
ONONDAGA COUNTY GREEN STREETS CSO 060/077

VINCENT STREET, SYRACUSE, NEW YORK 13210
TASK ORDER #2020-005G

AS BUILT


FEBRUARY, 2022

EDR Job #19008

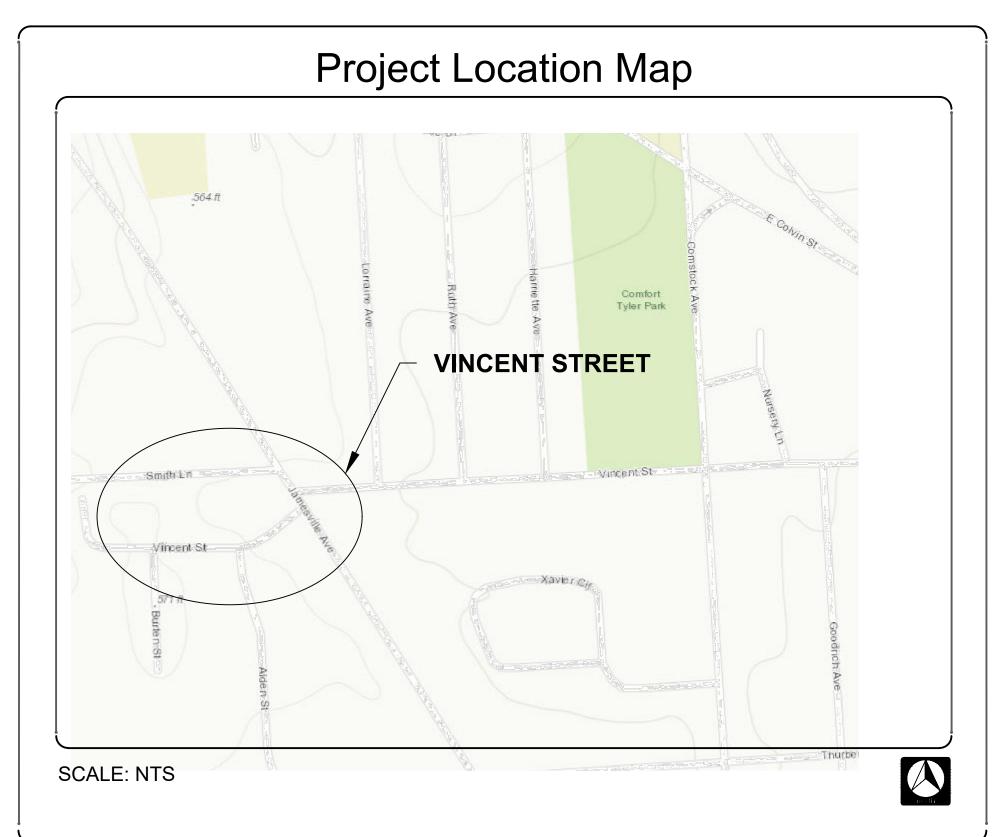

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AS BUILT DRAWING

THESE DRAWINGS HAVE BEEN REVISED TO REFLECT MAJOR CHANGES, IF ANY, WHICH OCCURRED DURING CONSTRUCTION. REVISIONS ARE BASED UPON INFORMATION SUPPLIED BY CONTRACTOR.

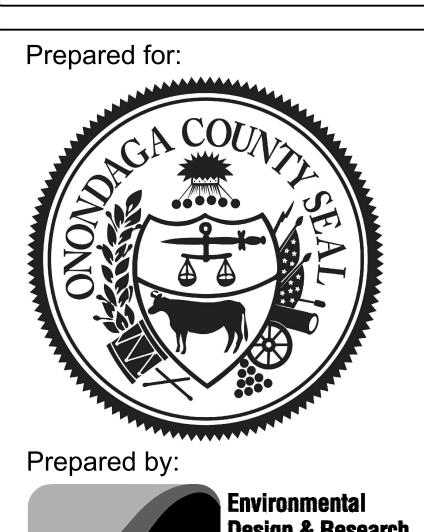DATE: <u>2/19/2022</u> PER: <u>Michael E. Tamblin</u>

A. GENERAL NOTES

- 1. PROVIDE TEMPORARY FENCING AND ADEQUATE SIGNAGE TO MAINTAIN SECURITY AT ALL TIMES IN ORDER TO PROTECT THE WORK IN PROGRESS. OPEN EXCAVATIONS SHALL BE PROPERLY PROTECTED AT ALL HOURS. ALL EXCAVATIONS SHALL BE BACK FILLED AT THE END OF EACH DAY.
- 2. NOTIFY DIG SAFELY NEW YORK (811) AT LEAST 72 HOURS PRIOR TO CONSTRUCTION.
- 3. CONTRACTOR SHALL NOTIFY ALL UTILITY PURVEYORS AT LEAST 72 HOURS IN ADVANCE OF STARTING ANY WORK.
- 4. VERIFY ALL EXISTING UTILITIES AND OTHER IMPROVEMENTS PRIOR TO START OF WORK AND IMMEDIATELY NOTIFY ENGINEER OF POTENTIAL CONFLICTS WITH PROPOSED WORK.
- 5. PROTECT EXISTING TREES AND OTHER SITE AMENITIES INDICATED TO REMAIN DURING CONSTRUCTION. INSTALL PROTECTIVE FENCING AS INDICATED ON THE DRAWINGS. EXERCISE ALL REASONABLE CARE WHEN WORKING IN CLOSE PROXIMITY TO EXISTING VEGETATION TO AVOID DAMAGE. AVOID THE USE OF 29. REPAIR ALL CONSTRUCTION ACCESS PATHWAYS TO PRE-CONSTRUCTION HEAVY EQUIPMENT OR STOCKPILING MATERIALS WITHIN THE TREES' DRIP LINE.
- 6. THE CONTRACTOR SHALL PREPARE A TRAFFIC CONTROL PLAN FOR VEHICULAR AND PEDESTRIAN TRAFFIC IN ACCORDANCE WITH THE FEDERAL HIGHWAY ADMINISTRATION MANUAL ON UNIFORM TRAFFIC CONTROL DEVICES FOR STREETS AND HIGHWAYS (MUTCD). TRAFFIC CONTROL PLAN SHALL BE APPROVED BY THE CITY OF SYRACUSE PRIOR TO THE COMMENCEMENT OF ALL CONSTRUCTION ACTIVITIES. ALL TRAFFIC CONTROL DEVICES SHALL REMAIN IN PLACE AND BE PROPERLY MAINTAINED FOR THE DURATION OF THE WORK.
- 7. THE CONTRACTOR SHALL APPLY FOR ALL REQUIRED PERMITS AND PAY ALL REQUIRED FEES BY GOVERNING AGENCIES HAVING JURISDICTION OVER THE FACILITIES AND NATURAL FEATURES FOUND ON THE SITE
- 8. ALL WORK AND AMENITIES SHOWN ON THE CONTRACT DOCUMENTS SHALL BE CONSIDERED "NEW" UNLESS INDICATED TO BE "EXISTING".
- 9. THE CONTRACTOR SHALL SCHEDULE THE CONSTRUCTION SEQUENCE TO MAINTAIN CONTINUITY OF ACTIVITIES WITHOUT DELAYS
- 10. THE CONTRACTOR SHALL BECOME FAMILIAR WITH THE EXISTING SITE CONDITIONS PRIOR TO THE START OF ANY CONSTRUCTION SITE DISTURBANCE. 3. VERTICAL DATUM IS DAVD 1988 DAUM.
- 11. THE CONTRACTOR SHALL TAKE ALL NECESSARY PRECAUTIONS AND MAKE ALL 4. NECESSARY PROVISIONS FOR PROTECTION OF THE PUBLIC, THE WORKMEN AND THE WORK, AND FOR MAINTENANCE AND PROTECTION OF PEDESTRIAN AND VEHICULAR TRAFFIC AS REQUIRED BY THE AGENCIES OF GOVERNMENT HAVING JURISDICTION.
- 12. THE CONTRACTOR SHALL ADHERE TO ALL OCCUPATIONAL SAFETY AND HEALTH ADMINISTRATION (OSHA), STATE AND LOCAL SAFETY REGULATIONS.
- 13. PROMPTLY REPORT TO THE ENGINEER ANY DISCREPANCIES FOUND ON THE SITE OR IN THE CONTRACT DOCUMENTS FOR REVIEW AND RESOLUTION BEFORE PROCEEDING WITH THE WORK IN THE AREA IN QUESTION. PROVIDE FIELD INFORMATION SPECIFIC TO THE DISCREPANCY TO EXPEDITE RESOLUTION.
- 14. THE CONTRACTOR IS RESPONSIBLE FOR PROVIDING A NEW YORK STATE LICENSED LAND SURVEYOR FOR THE LAYOUT AND STAKEOUT OF ALL SITE WORK AND PREPARATION OF AS-BUILT SURVEY. ENGINEER SHALL SUPPLY AUTOCAD FILES OF BASE SURVEY TO CONTRACTOR FOR HORIZONTAL
- 15. AT CLOSE OF PROJECT, CONTRACTOR SHALL VERIFY INVERT ELEVATIONS OF ALL STRUCTURES USING A NYS LICENSED SURVEYOR. THE CONTRACTOR SHALL PREPARE AS-BUILT RECORD DRAWING SHOWING RIMS, INVERTS, PIPE SIZES, PIPE LOCATIONS PIPE BENDS, CLEANOUTS, BLIND CONNECTIONS, ETC.
- 16. LOCATE, PROTECT, AND MAINTAIN BENCHMARKS, MONUMENTS, CONTROL POINTS AND PROJECT SURVEYING REFERENCE POINTS.
- 17. AVOID ANY DISTURBANCE OF EXISTING VEGETATION ON THE SITE EXCEPT THE VEGETATION SPECIFICALLY DESIGNATED TO BE REMOVED
- 18. TAKE ALL PRECAUTIONS NECESSARY TO PREVENT EROSION AND CONTROL SEDIMENTATION AS REQUIRED BY THE AGENCIES OF GOVERNMENT HAVING
- 19. THE CONTRACTOR SHALL BE RESPONSIBLE FOR ALL DEWATERING AND MAINTENANCE OF SURFACE WATER AND/OR GROUNDWATER ENCOUNTERED DURING THE COURSE OF WORK.
- 20. COMPLY WITH ALL LOCAL, STATE AND FEDERAL REQUIREMENTS REGARDING MATERIALS, METHODS OF WORK AND DISPOSAL OF EXCESS AND WASTE
- 21. BURNING OF MATERIALS OF ANY DESCRIPTION ON THE SITE IS PROHIBITED.
- 22. PRIOR TO THE START OF WORK, THE CONTRACTOR SHALL
- A. REVIEW THE CONTRACT DOCUMENTS FOR ACCURACY OF EXISTING CONDITIONS. THE CONTRACTOR SHALL NOTIFY THE ENGINEER OF ANY DISCREPANCIES. BY COMMENCING CONSTRUCTION, THE CONTRACTOR ACCEPTS THE CONTRACT DOCUMENTS AS ACCURATELY REPRESENTING THE EXISTING SITE CONDITIONS.
- B. ESTABLISH THE LIMITS OF ALL AREAS TO BE DISTURBED.
- C. PROVIDE EXPLORATORY EXCAVATIONS AND COORDINATE ALL PIPING LAYOUTS WITH THE ENGINEER TO ELIMINATE ALL CONFLICTS WITH EXISTING UTILITIES.
- 22. THE USE OF EXPLOSIVES OF ANY DESCRIPTION ON THE SITE IS PROHIBITED.
- 23. CONSTRUCTION DEBRIS AND DEMOLISHED MATERIALS SHALL BE REMOVED FROM THE SITE DAILY AS DETERMINED BY THE ENGINEER AND SHALL NOT BE ALLOWED TO ACCUMULATE. EMPLOY APPROPRIATE MEASURES TO PREVENT LOOSE DEBRIS FROM LEAVING THE CONSTRUCTION AREA.
- 24. ALL FACILITIES TO BE CONSTRUCTED OR INSTALLED SHALL COMPLY WITH ALL 7. THE CONTRACTOR IS PERMITTED TO SALVAGE ALL MATERIALS AND

- SECTIONS AND LATEST REVISIONS OF THE REQUIREMENTS OF ALL AGENCIES OF GOVERNMENT HAVING JURISDICTION.
- 25. LONG LEAD AND SCARCE MATERIALS SHALL BE ORDERED IN A TIMELY MANNER TO PREVENT AVOIDABLE CONSTRUCTION DELAYS.
- 26. THE CONTRACTOR IS RESPONSIBLE FOR ALL DAMAGE CAUSED BY CONSTRUCTION TO EXISTING UTILITIES AND FACILITIES WHICH ARE NOT INCLUDED AS PART OF THE INTENDED WORK. THE CONTRACTOR SHALL REPAIR, RESTORE AND/OR REPLACE ALL DAMAGE TO THE SATISFACTION OF ENGINEER AT NO ADDITIONAL COST TO THE OWNER.
- 27. THE CONTRACTOR SHALL RESTORE ALL DISTURBED SURFACES TO ORIGINAL OR BETTER CONDITION INCLUDING 6 INCHES OF TOPSOIL, SEED, FERTILIZER, AND MULCH. OTHER SURFACES SHALL BE RESTORED AS SHOWN ON THE DETAILS.
- IMMEDIATELY FOLLOWING CONSTRUCTION, RETURN ALL EXISTING
- IMPROVEMENTS TO PRE-CONSTRUCTION CONDITIONS.
- CONDITIONS AT THE CONCLUSION OF WORK.
- BELOW PER SYRACUSE WATER DEPARTMENT STANDARDS, DETAIL TU.01, IF ENCOUNTERED DURING THE WORK OF THIS CONTRACT: 128 VINCENT STREET

30. REPLACE EXISTING LEAD WATER SERVICES TO THE PROPERTIES LISTED

- 129 VINCENT STREET
- 204 VINCENT STREET
- 31. SIDEWALK SHALL BE REPLACED IN FULL PANELS IN GOOD CONDITION TO NEAREST JOINT.
- 32. ALL ASPHALT AND CONCRETE WALKS REMOVED ON DEMOLITION PLAN SHALL BE REPLACED WITH CITY OF SYRACUSE STANDARD CONCRETE WALKS.

B. SURVEY NOTES

- THE BOUNDARY AND TOPOGRAPHIC SURVEY INFORMATION SHOWN ON THIS PLAN WERE PREPARED BY BRYANT ASSOCIATES, P.C. AND DATED MARCH 2018
- 2. HORIZONTAL DATUM IS NAD 83 DATUM.
- SUBSURFACE UTILITY INFORMATION WAS OBTAINED FROM FIELD SURVEY AND FROM RESPECTIVE UTILITY PURVEYORS AND THEIR LOCATIONS AS SHOWN ARE APPROXIMATE AND SHALL BE VERIFIED BY THE CONTRACTOR PRIOR TO ANY SOIL DISTURBANCE. VERIFY ALL EXISTING UTILITIES AND OTHER IMPROVEMENTS PRIOR TO START OF WORK AND IMMEDIATELY NOTIFY ENGINEER OF POTENTIAL CONFLICTS WITH PROPOSED WORK
- THE LOCATIONS OF STREET RIGHT-OF-WAY LINES ARE APPROXIMATE AND WERE PLOTTED FOR GRAPHICAL REPRESENTATION ONLY USING TAX MAP INFORMATION AND THE CITY OF SYRACUSE RIGHT-OF-WAY PLAT MAPS. NO TITLE DOCUMENTS WERE PROVIDED OR REVIEWED AT THE TIME OF THIS SURVEY.
- 6. THE CONTRACTOR'S ATTENTION IS DIRECTED TO ALL APPLICABLE LAWS REGARDING LIABILITY INCURRED THROUGH THE DISTURBANCE AND DESTRUCTION OF GEODETIC SURVEY MONUMENTS
- CITY OF SYRACUSE MONUMENTS SHALL NOT BE DISTURBED OR DESTROYED. IF THERE IS A CONFLICT OR A SURVEY MONUMENT IS WITHIN FIVE FEET OF CONSTRUCTION THE CITY OF SYRACUSE DEPARTMENT OF ENGINEERING MUST BEGINS.

C. DEMOLITION PLAN NOTES

- UNLESS INDICATED "REMOVE AND SALVAGE" OR "REMOVE AND REUSE," ALL ITEMS INDICATED "REMOVE" SHALL BE DEMOLISHED, HAULED OFF-SITE AND DISPOSED OF IN STRICT COMPLIANCE WITH THE REQUIREMENTS OF ALL AGENCIES OF GOVERNMENT HAVING JURISDICTION
- EXERCISE ALL REASONABLE CARE IN REMOVING AND HANDLING EXISTING ON-SITE MATERIALS INDICATED FOR SALVAGE TO THE OWNER OR FOR REUSE ON THE SITE.
- 3. FLAG OR OTHERWISE MARK IN A NON-PERMANENT MANNER ALL TREES SHOWN FOR REMOVAL ADJACENT TO OR IN CLOSE PROXIMITY TO THE LIMITS OF WORK FOR REVIEW BY THE ENGINEER PRIOR TO ANY REMOVAL. THE ENGINEER RESERVES THE RIGHT TO ADJUST THE CLEARING LIMITS.

4. IF A CONFLICT WITH EXISTING UTILITIES IS DISCOVERED, THE CONTRACTOR

- SHALL IMMEDIATELY MAKE THE ENGINEER AWARE OF THE CONFLICT. AFTER THE ENGINEER PROVIDES A RESOLUTION TO THE CONFLICT, IF ANY RELOCATIONS OF UTILITIES ARE REQUIRED, THE CONTRACTOR SHALL PERFORM WORK AND PROVIDE ALL MATERIALS NECESSARY TO DISCONNECT OR RELOCATE EXISTING UTILITIES IN ACCORDANCE WITH THE CITY OF SYRACUSE AND ONONDAGA COUNTY REQUIREMENTS. COORDINATE WITH THE RESPECTIVE UTILITY COMPANIES FOR SHUTOFF AND RECONNECTION OF ACTIVE SERVICES. THE CONTRACTOR SHALL RECORD EXISTING UTILITY TERMINATION POINTS BEFORE DISCONNECTION.
- WHERE EXISTING PAVEMENT IS TO BE REMOVED, SAW CUT THE PAVEMENT EDGE TO PROVIDE A TRUE, NEAT AND CLEAN EDGE AGAINST WHICH TO ABUT WORK OF THIS CONTRACT PER DETAILS PS.01 AND PS.02.
- ALL ABANDONED PIPES TO REMAIN ARE TO BE FILLED WITH CONTROLLED LOW STRENGTH CONCRETE, EXCEPT THOSE CONNECTED TO A COMBINED SEWER. THOSE LATERALS WILL BE DISCONNECTED, CAPPED, AND ABANDONED IN PLACE PER THE CITY OF SYRACUSE AND ONONDAGA COUNTY PLUMBING CONTROL REQUIREMENTS.

- EQUIPMENT FROM THE DEMOLITION WORK EXCEPT FOR MATERIALS AND EQUIPMENT SHOWN OR SPECIFIED TO BE REMOVED AND DELIVERED TO AN ON-SITE LOCATION TO BE NAMED BY THE ENGINEER.
- 8. ALL SALVAGED MATERIALS AND EQUIPMENT SHALL BE TAKEN OFF-SITE IMMEDIATELY UPON REMOVAL. NO ON-SITE STORAGE IS ALLOWED EXCEPT FOR TOPSOIL. NO RE-USE OF SALVAGED MATERIALS IS ALLOWED IN THIS CONTRACT. NO SALE OF SALVAGED ITEMS IS ALLOWED ON THE PROJECT SITE.

D. EROSION & SEDIMENT CONTROL NOTES

- EROSION CONTROLS MUST BE CONSTRUCTED, STABILIZED, AND FUNCTIONAL BEFORE SITE DISTURBANCE BEGINS WITHIN THE TRIBUTARY AREAS OF THOSE CONTROLS.
- PROVIDE EROSION AND SEDIMENT CONTROL MEASURES WHERE AND WHEN APPROPRIATE AS PER THE NEW YORK STATE STANDARDS AND SPECIFICATIONS FOR EROSION AND SEDIMENT CONTROL, LATEST EDITION. PROTECT EXISTING SITE FEATURES UNLESS OTHERWISE NOTED. CONSULT ENGINEER PRIOR TO STORMWATER MANAGEMENT PRACTICE INSTALLATION. CONTRACTOR SHALL TAKE ALL OTHER MEASURES TO POSITIVELY PRECLUDE
- ERODED MATERIALS FROM LEAVING THE SITE 4. VEGETATION SHALL BE PROTECTED OUTSIDE OF THE LIMITS OF DISTURBANCE.
- 5. AFTER FINAL SITE STABILIZATION HAS BEEN ACHIEVED, TEMPORARY EROSION CONTROLS MUST BE REMOVED AND AREAS DISTURBED DURING REMOVAL OF THE THE CONTROLS MUST BE STABILIZED IMMEDIATELY.
- UNTIL THE SITE IS STABILIZED, ALL EROSION CONTROLS MUST BE MAINTAINED PROPERLY. MAINTENANCE MUST INCLUDE INSPECTIONS OF ALL EROSION CONTROLS AFTER EACH RUNOFF EVENT AND ON A WEEKLY BASIS. ALL PREVENTATIVE AND REMEDIAL MAINTENANCE WORK, INCLUDING CLEAN OUT REPAIR, REPLACEMENT, RE-GRADING, RE-SEEDING, RE-MULCHING, AND RE-NETTING MUST BE PREFORMED IMMEDIATELY. IF EROSION CONTROLS FAIL TO PERFORM AS EXPECTED, REPLACEMENT CONTROLS, OR MODIFICATIONS OF THOSE INSTALLED WILL BE REQUIRED.
- 7. ALL EROSION AND SEDIMENT CONTROL DEVICES AND THE CONSTRUCTION FENCE SHALL BE CONSTRUCTED AND OPERATED IN ACCORDANCE WITH THEIR DESIGN, AND MAINTAINED TO ASSURE CONTINUED PERFORMANCE OF THEIR INTENDED FUNCTION THROUGHOUT THE CONSTRUCTION PROCESS.
- CONTRACTOR SHALL VACUUM ALL FILTER INSERTS AND ALL MANHOLES, PIPES, CATCH BASINS AND STRUCTURE SUMPS BEFORE BENEFICIAL OCCUPANY/SUBSTANTIAL COMPLETION/PROJECT CLOSEOUT, AND TWICE A YEAR DURING CONSTRUCTION.
- MAINTENANCE AND REPAIR OF ALL EQUIPMENT AND VEHICLES INVOLVING OIL CHANGES, HYDRAULIC SYSTEM AND FUEL TANK DRAIN DOWN, DEGREASING OPERATIONS AND OTHER ACTIVITIES THAT MAY RESULT IN THE ACCIDENTAL RELEASE OF CONTAMINANTS MUST BE CONDUCTED OFF-SITE. ACCIDENTAL SPILLS MUST BE CLEANED UP IMMEDIATELY AND CONTAMINANTS DISPOSED OF PROPERLY.
- 10. DISTURBED AREAS SHALL BE AS SMALL AS PRACTICAL, AND SHALL BE RESTORED, IMPROVED OR TEMPORARILY STABILIZED WITHIN 48 HOURS OF COMPLETION OF WORK.
- 11. THE CONTRACTOR SHALL TAKE THE NECESSARY MEASURES, INCLUDING WATER SPRINKLING TO PROVIDE DUST CONTROL DURING CONSTRUCTION. BE CONTACTED AT (315) 448-8207 BEFORE ANY DEMOLITION OF CONSTRUCTION 12. ADJUST LOCATION OF TOPSOIL STOCKPILE AS NEEDED AND AS APPROVED BY THE OWNERS REPRESENTATIVE TO OPTIMIZE CONSTRUCTION STAGING AND

TO AVOID INCREASING DISTURBANCE AREA.

DRAINAGE NOTES

- EXISTING TOPOGRAPHY, STRUCTURES, AND SITE FEATURES ARE SHOWN SCREENED AND/OR LIGHT-LINED. NEW FINISH GRADE, STRUCTURES, AND SITE FEATURES ARE SHOWN HEAVY-LINED.
- ELEVATIONS GIVEN ARE TO FINISH GRADE UNLESS OTHERWISE SHOWN.
- AGGREGATE FOR INFILTRATION AREA SHALL CLEANED-WASHED PRIOR TO
- WHEN ENCOUNTERED WITHIN THE REQUIRED STORMWATER FACILITY EXCAVATION, CONTRACTOR SHALL WRAP EXISTING UTILITIES WITH 40 MIL GEOMEMBRANE SHEETING AND SECURE WITH PVC TAPE AT 2'-0" O.C (MAX) OVERLAP SHEETING BY 2'-0" (MIN). EXTEND SHEETING A MINIMUM OF $\frac{1}{4}$ OF THE PIPE CIRCUMFERENCE AND ENSURE OVERLAP RUNS ALONG THE CROWN OF THE PIPE. SLEEVES AND CASTINGS SHALL BE DRY AND MOISTURE FREE BEFORE SEALING.
- ALL GRATES AND COVERS FOR STORM SEWER STRUCTURES SHALL BE LOCKABLE EXCEPT CITY OF SYRACUSE TYPE A CATCH BASINS.
- 6. PROVIDE PERMANENT FILTER INSERTS (P.1. 1.19A) FOR ALL NEW AND EXISTING STORM DRAINAGE INLETS AND CATCH BASINS, AFFECTED BY OR CONNECTED TO GI IMPROVEMENTS WORK AS SPECIFIED.
- MEET THE LINE AND GRADE OF EXISTING CONDITIONS AT THE LIMITS OF WORK. TRANSITIONS TO EXISTING CONDITIONS SHALL BE SMOOTH AND UNIFORM WITHOUT ABRUPT CHANGES IN GRADE.
- CLEAN AND RESTORE EXISTING DRAINAGE DITCHES AND/OR PIPES TO REMAIN THAT ARE AFFECTED BY CONSTRUCTION TO FUNCTIONING CONDITION.
- TOP DRESS WITH MINIMUM 6" OF TOP SOIL, SEED AND MULCH ALL LAWN AREAS DISTURBED BY THE CONSTRUCTION AS SOON AS THE FINISHED GRADING OPERATION IS COMPLETED.
- 10. THE CONTRACTOR IS RESPONSIBLE FOR VERIFYING RIM ELEVATIONS IN RELATION TO THE PROPOSED GRADES PRIOR TO INSTALLATION.
- 11. THE ENGINEER WILL REVIEW THE LAYOUT OF ALL UTILITIES IN THE FIELD BEFORE INSTALLATION. THE CONTRACTOR SHALL SCHEDULE 72 HOURS

- ADVANCED NOTIFICATION TO THE ENGINEER TO FACILITATE TIMELY REVIEW.
- 12. ADJUST THE RIM ELEVATIONS OF EXISTING UTILITY STRUCTURES SCHEDULED TO REMAIN TO BE FLUSH WITH THE FINISHED GRADE ELEVATIONS.
- 13. WHEN PLACING PIPE IN THE EXCAVATION, POSITION THE BELL OF THE PIPE ON THE UPSTREAM END.
- 14. THE CONTRACTOR SHALL SEE THAT ALL NECESSARY PERMITS, CERTIFICATIONS, AND/OR INSPECTIONS REQUIRED BY CODES AND/OR UTILITY SERVICE PROVIDERS, SHALL BE PERFORMED/OBTAINED PRIOR TO FINAL CONNECTION OF SERVICES.
- 15. FOR WORK WITHIN THE RIGHT-OF-WAY, THE REQUIREMENTS OF THE HIGHWAY OWNER SHALL BE ADHERED TO FOR ITEMS ABOVE THE PIPE BEDDING. INCLUDING, BUT NOT LIMITED TO, MAINTENANCE AND PROTECTION OF TRAFFIC, BACKFILL MATERIAL, AND SURFACE RESTORATION.
- 16. ALL EXPOSED BOLTS, RODS, OR METALS TO BE BURIED SHALL BE COATED WITH COAL TAR TO PREVENT CORROSION.
- 17. THE CONTRACTOR SHALL MAINTAIN EXISTING SANITARY SEWER AND WATER SERVICES AT ALL TIMES, EXCEPT DURING APPROVED AND SCHEDULED
- 18. ROOT REMOVAL SHALL BE REVIEWED AND APPROVED BY THE CITY OF SYRACUSE ARBORIST.
- 19. ROOTS SHALL BE REMOVED FROM EXISTING PIPES IN THE DESIGNATED SECTIONS WHERE ROOT INTRUSION IS A PROBLEM. ROOTS SHALL BE REMOVED WITH HIGH-VELOCITY JET CLEANERS COMBINED WITH A ROOT CUTTING BLADE OF APPROPRIATE SIZE. AFTER ROOTS HAVE BEEN CUT, POST CLEANING AND TELEVISING OF THE DESIGNATED SECTIONS IS REQUIRED. ACCEPTANCE OF ROOT REMOVAL SHALL BE MADE UPON COMPLETION OF THE TELEVISION INSPECTION AND SHALL BE TO THE SATISFACTION OF THE ENGINEER. THE CONTRACTOR SHALL PROVIDE THE TELEVISION INSPECTION AT NO ADDITIONAL COST TO THE OWNER.
- 20. ALL STRUCTURES SHALL MEET AASHTO H20 LOADING REQUIREMENTS, UNLESS OTHERWISE NOTED.
- 21. ANY NEW LATERALS SHALL BE INSTALLED WITH A MINIMUM 1/4" PER FOOT
- 22. THE CONTRACTOR IS RESPONSIBLE FOR HANDLING, CUTTING AND DISPOSAL OF ALL ASBESTOS CEMENT (AC) PIPE TO BE REMOVED OR CUT IN ACCORDANCE WITH ALL APPLICABLE REGULATIONS.
- 23. ALL PROPOSED MANHOLE RIMS ARE TO BE ADJUSTED TO MEET FINISHED GRADE, AS REQUIRED.
- 24. ALL EXISTING DRAINAGE FACILITIES SHALL BE MAINTAINED FREE OF DEBRIS AND FOREIGN MATTER AND BE IN OPERATION THROUGHOUT CONSTRUCTION.
- 25. THE CONTRACTOR SHALL PROVIDE A CONCRETE WASHOUT AREA WITHIN THE PROJECT AREAS IN ACCORDANCE WITH THE NEW YORK STATE STANDARDS GROUND SPECIFICATIONS FOR EROSION AND SEDIMENT CONTROL.

217 Montgomery Street, Suite 1000 Syracuse, New York 13202 P. 315.471.0688



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DATE: **5/14/2020** EDR Job#: 19008 DRAWN BY: BL VINCENT STREET

THESE DRAWINGS HAVE BEEN REVISED TO REFLECT

DATE: <u>2/19/2022</u> PER: <u>Michael E. Tamblin</u>

INFORMATION SUPPLIED BY CONTRACTOR.

MAJOR CHANGES, IF ANY, WHICH OCCURRED DURING CONSTRUCTION. REVISIONS ARE BASED UPON

NON

DRAWING NUMBER

		SYMBOL	LEGE	END	
	CONTROL UTILITIES				UTILITIES
0	ΙΡ	IRON PIPE	©	GMH	GAS MANHOLE
0	RBAR	REBAR	G	GM	GAS METER
۵	DISK	DISK	GR O	GRI	GAS RISER
<u> </u>	HUB	HUB	⊗	GV	GAS VALVE
<u> </u>	NAIL	NAIL	FP	FP	FUEL PUMP
۵	PK	PK NAIL	0	GFI	GAS FILLER
<u> </u>	RR	RAILROAD SPIKE	٨	GW	GUY WIRE
<u> </u>	STA	STATION	<u>s</u>	SAMH	SANITARY SEWER MANHOLE
		SURVEY	<u>\$</u>	SAMHB	BURIED SANITARY SEWER MANHOLE
	ВМ	BENCHMARK	0	CSMH	COMBINED SEWER MANHOLE
BOR ●	BOR	BORING	0	СЅМНВ	BURIED COMBINED SEWER MANHOLE
0	мw	MONITORING WELL	sco	SC0	SANITARY SEWER CLEAN OUT
0	MON	MONUMENT	sv O	SV	SANITARY SEWER VENT
0	IR	IRON ROD	<u></u>	STMMH	STEAM MANHOLE
<u> </u>	HOLE	DRILL HOLE	SMV	STMV	STEAM VENT
	l	SIGNS	<u></u>	СВ	CATCH BASIN
0	S1	1 POLE SIGN	•	CBR	ROUND CATCH BASIN
••	S2	2 POLE SIGN		DI	CURB CUT DRAINAGE
-	DEL	DELINEATOR	©	STMH	STORM SEWER MANHOLE
0 0	GUIDE	GUIDE SIGN	0	STMHB	BURIED STORM SEWER MANHOLE
-	ММ	MILE MARKER	⊗ ⊗	STVL	STORM SEWER VALVE
4	STR	STREET SIGN	DV O	STV	STORM SEWER VENT
<u> </u>	l	SITE	P	ТВ	TELEPHONE BOOTH
0	BOL	BOLLARD	H	TLHH	TELEPHONE HAND HOLE
0	BUOY	BUOY	1	TLMH	TELEPHONE MANHOLE
0	BUP	BACKUP POST	0	TLPED	TELEPHONE PEDESTAL
0	PILE	PILE	<u> </u>	TLPB	TELEPHONE PULL BOX
0	POST	POST	TR O	TLRI	TELEPHONE RISER
-+	DWELL	DRY WELL		TCTRL	TRAFFIC CONTROLLER
₽ _	FPOL	FLAG POLE	H	TRHH	TRAFFIC HAND HOLE
•	MB	MAILBOX		TRMH	TRAFFIC MANHOLE
⊕	PM	PARKING METER	0	TRP	TRAFFIC POLE
SAT	SAT	SATELLITE	<u>)</u>	TRPC	TRAFFIC POLE WITH CONTROLER
®	WELL	WELL	<u>)</u> 0	TRPB	TRAFFIC PULL BOX
₽ -	WFLG	WETLAND FLAG	 &P	TRWK	WALK LIGHT
	25	VEGETATION	□ PIV ⊗	PIV	POST INDICATOR VALVE
*	TRC	CONIFEROUS TREE	Q	HYD	HYDRANT
	TRD	DECIDUOUS TREE	ws	WS	WATER SERVICE
-+	SHRUB	SHRUB	(W)	WMP	WATER METER PIT
_	STUMP	TREE STUMP	₩	WMH	WATER MANHOLE
	O I O IVII	UTILITIES	w) ⊗	SPIG	WATER SPIGOT
\otimes	UMH	UNKNOWN MANHOLE	₩	SPK	WATER SPRINKLER
	UMHB	UNKNOWN MANHOLE BURIED	₩	WV	WATER VALVE
<u> </u>	UP	UTILITY POLE	₩	WVB	WATER VALVE BURIED
<u> </u>	UPWD	UTILITY POLE WITH DROP	(CI)	CLMH	CHLORINE MANHOLE
$\frac{1}{2}$	LP	LIGHT POLE	U	OLIVIIT	RAILROAD
<u> </u>	LP	UTILITY POLE WITH LIGHT		RRLT	RAILROAD LIGHT
<u></u> Ы	UHH	HAND HOLE		RRSW	RAILROAD LIGHT
$=$ \dagger	CPED	CABLE PEDESTAL		SCU	BRIDGE SCUPPER
<u> </u>					
© F	EMH	ELECTRICAL MANHOLE	\boxtimes	CLMK	CONCRETE ANCHOR
E	EM	ELECTRIC METER	1	CATE	CULVERT MARKER
Ē	ELPB	ELECTRIC PULL BOX	0	GATE	GATE POST
፼ Ⅰ	רורי '	LI LUTDIU DICED '			
© ©	ELRI GCP	ELECTRIC RISER GAS CP TEST			

LINE LEGEND				
	BOTTOM OF BANK			
	TOP OF BANK			
	EDGE OF WOODS			
	CHAIN LINK FENCE			
	WOOD FENCE			
× × ×	OTHER FENCE			
o	GUIDE RAIL			
EP	EDGE OF PAVEMENT			
ES	EDGE OF SHOULDER			
CLVT	CULVERT			
uc	UNDERGROUND CABLE			
oc	OVERHEAD CABLE			
UF	UNDERGROUND FIBER OPTICS			
UTUT	UNDERGROUND TELEPHONE			
отот	OVERHEAD TELEPHONE			
UEUE	UNDERGROUND ELECTRIC			
OE	OVERHEAD ELECTRIC			
	TRAFFIC LOOP WIRE			
UTRUTR	UNDERGROUND TRAFFIC			
	OVERHEAD TRAFFIC			
OHW	OVERHEAD WIRE			
cscs	COMBINED SEWER LINE			
SA	SANITARY SEWER LINE			
stst	STORM SEWER LINE			
	UNDERGROUND GAS			
STMSTM	STEAM			
STRSTR	STEAM RETURN			
aa	CHLORINE LINE			
w	WATER LINE			
ABDN——ABDN——	ABANDONED UTILITY			
UNK	UNKNOWN UTILITY			
e	PROPERTY LINE			
	RIGHT OF WAY			

ABBREVIATIONS

AMERICANS WITH DISABILITIES ACT ASC ANTI-SEEPAGE COLLAR AVG AVERAGE **BOTTOM OF CURB** вс CB CATCH BASIN CONC CONCRETE DA DRAINAGE AREA DIA DIAMETER DWG DRAWING ELEV **ELEVATION** EX **EXISTING** FOOT, FEET FIRE HYDRANT NATURAL GAS HDPE HIGH-DENSITY POLYETHYLENE INF INFILTRATION TRENCH

INV LF LINEAR FEET DRAINAGE MANHOLE DMH SMH SANITARY MANHOLE

NYSDOT NEW YORK STATE DEPARTMENT OF TRANSPORTATION OVERHEAD ELECTRIC

PERF PERFORATED PSI POUNDPER SQUARE INCH PVC POLYVINYL CHLORIDE ROW RIGHT OF WAY SAN SANITARY ST STORM TC TOP OF CURB TYP TYPICAL POTABLE WATER WQv WATER QUALITY VOLUME

PAY ITEMS:

NOTE - VARIOUS STAND ALONE PAY ITEMS APPLY TO THIS PROJECT AND HAVE NOT BEEN SPECIFICALLY IDENTIFIED IN DRAWING SET. THESE PAY ITEMS INCLUDE:

1.1 SITE CLEARING AND DISPOSAL 1.5B COMMON GRADING AND BACKFILL

1.5C SCARIFY SUBGRADE 1.8 **ESTABLISHING TURF** 1.12 MODULAR TREE CELL SOIL

1.14 TOPSOIL 1.15 MULCH

1.231 SOLID HDPE 45° FITTING UP TO 12" DIAMETER

1.23K SOLID HDPE 90° ELBOW FITTING UP TO 12" DIAMETER

1.33 IMPERMEABLE LINER 1.35B CURVED GRANITE CURB

1.36A STRAIGHT FLUSH GRANITE CURB 1.36B CURVED FLUSH GRANITE CURB

1.36C GRANITE TRANSITION CURB 1.42A EMBEDDED DETECTABLE WARNING UNITS - NEW

1.42B EMBEDDED DETECTABLE WARNING UNITS - RETROFIT 1.61A SOLID PAINTED PAVEMENT MARKINGS - 6"

2.1 PERFORMANCE AND PAYMENT BOND PREMIUM(S) AS REQUIRED

CITY OF SYRACUSE PERMITS, AS REQUIRED

3.2 MAINTENANCE AND PROTECTION OF TRAFFIC RECORD DRAWING SURVEY BY NEW YORK STATE LICENSED

SURVEYOR

DETAIL KEY	
DETAIL NAME	CATEGORY AND NO.
TYPCIAL SECTION ASPHALT STREET PAVEMENT W/ ACC FOUNDATION	PS.01
TYPICAL SECTION PIPE TRENCHING/ROAD RESTORATION	PS.05
CONCRETE SIDEWALK OR DRIVEWAY - RESTORATION	PS.11
ADA CURB RAMP	PS.13
TYPICAL SECTION GRANITE CURB (NEW OR RESET) W/ PERF UNDERDRAIN (WHERE INDICATED)	PS.14
CONCRETE ENCASEMENT OR REINFORCEMENT OF PIPE	PS.21
CITY STANDARD CATCH BASIN TYPE A W/ FRAME & GRATE	DR.04
48" ROUND PRECAST CONCRETE MANHOLE W/FRAME AND LID OR GRATE	DR.07
CAST IRON TRAP	DR.08
"HALF PIPE" WEIR - SDR 35	DR.09
PIPE BEDDING NOT IN INFILTRATION TRENCH	DR.13
6" PVC CLEANOUT W/ CONCRETE COLLAR & LOCKABLE COVER	DR.14
ANTI-SEEP COLLAR	DR.16
PIPE CONNECTION TO EXISTING STRUCTURE/MANHOLE	DR.17
PIPE CONNECTION TO EXISTING SEWER MAIN	DR.18
WATERSTOP BETWEEN INFILTRATION BED AND ADJACENT SUBSURFACE FEATURE - VERTICAL	DR.22
GEOMEMBRANE-WRAPPED EXITING UTILITY	DR.23
INFILTRATION TRENCH UNDER PAVEMENT (ASPHALT, SIDEWALK OR PAVEMENT)	IS.01
EARTHEN BERM BETWEEN VARIED ELEVATION INFILTRATION BEDS	IS.05
NEW 1" WATER SERVICE (CURB BOX TO MAIN)	TU.01
SIGN POST FOUNDATION	TU.04
TREE PROTECTION FENCE	TU.11
TYPICAL DRIVEWAY ENTRANCES	TU.14
SILT FENCE	TU.16
COMPOST FILTER SOCK	TU.17
SHRUB PLANTING	LP.01
PERENNIAL AND GROUNDCOVER PLANTING	LP.02
TYPICAL B&B TREE PLANTING	LP.05
TREE STAKING	LP.06
TYPICAL TREE PLANTING IN PEDESTRIAN WAY	LP.07



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NG RE	DRAWING REVISIONS	
	REVISION	©2019 Environmental Design & Research, BY Landscape Architecture, Engineering,
10/4/19	50% RESUBMITTAL TO OCDWEP	The following is paraphrased from the New York Educat Law, Article 145, Section 7209, and Chapter II, Section
1/1/2020	90% SUBMITTAL TO OCDWEP	79-1.4, and applies to this drawing: "It is a violation of the law for any person unless he is acting under the direction a licensed professional provinces incored landscape.
4/28/2020	100% SUBMITTAL TO OCDWEP	architect or licensed land surveyor to alter an item in any way. If an item bearing the seal of an engineer, landsca
5/14/2020	FINAL SUBMITTAL TO OCDWEP	architect or land surveyor is altered, the altering enginee landscape architect or land surveyor shall affix to the ite
2/19/2022	AS BUILT	ins sea and the foldation lateration and a specific adactining of the alteration."

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JNONDAGA COUNTY SOW 119 GREEN STREETS	
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DATE: 5/14/2020

LEGENDS AND ABBREVIATIONS

EDR Job#: 19008 DRAWN BY: BL


AS BUILT DRAWING

THESE DRAWINGS HAVE BEEN REVISED TO REFLECT MAJOR CHANGES, IF ANY, WHICH OCCURRED DURING CONSTRUCTION. REVISIONS ARE BASED UPON

DATE: <u>2/19/2022</u> PER: <u>Michael E. Tamblin</u>


INFORMATION SUPPLIED BY CONTRACTOR.

FILE NAME: VINCENT STREET DRAWING NUMBER:

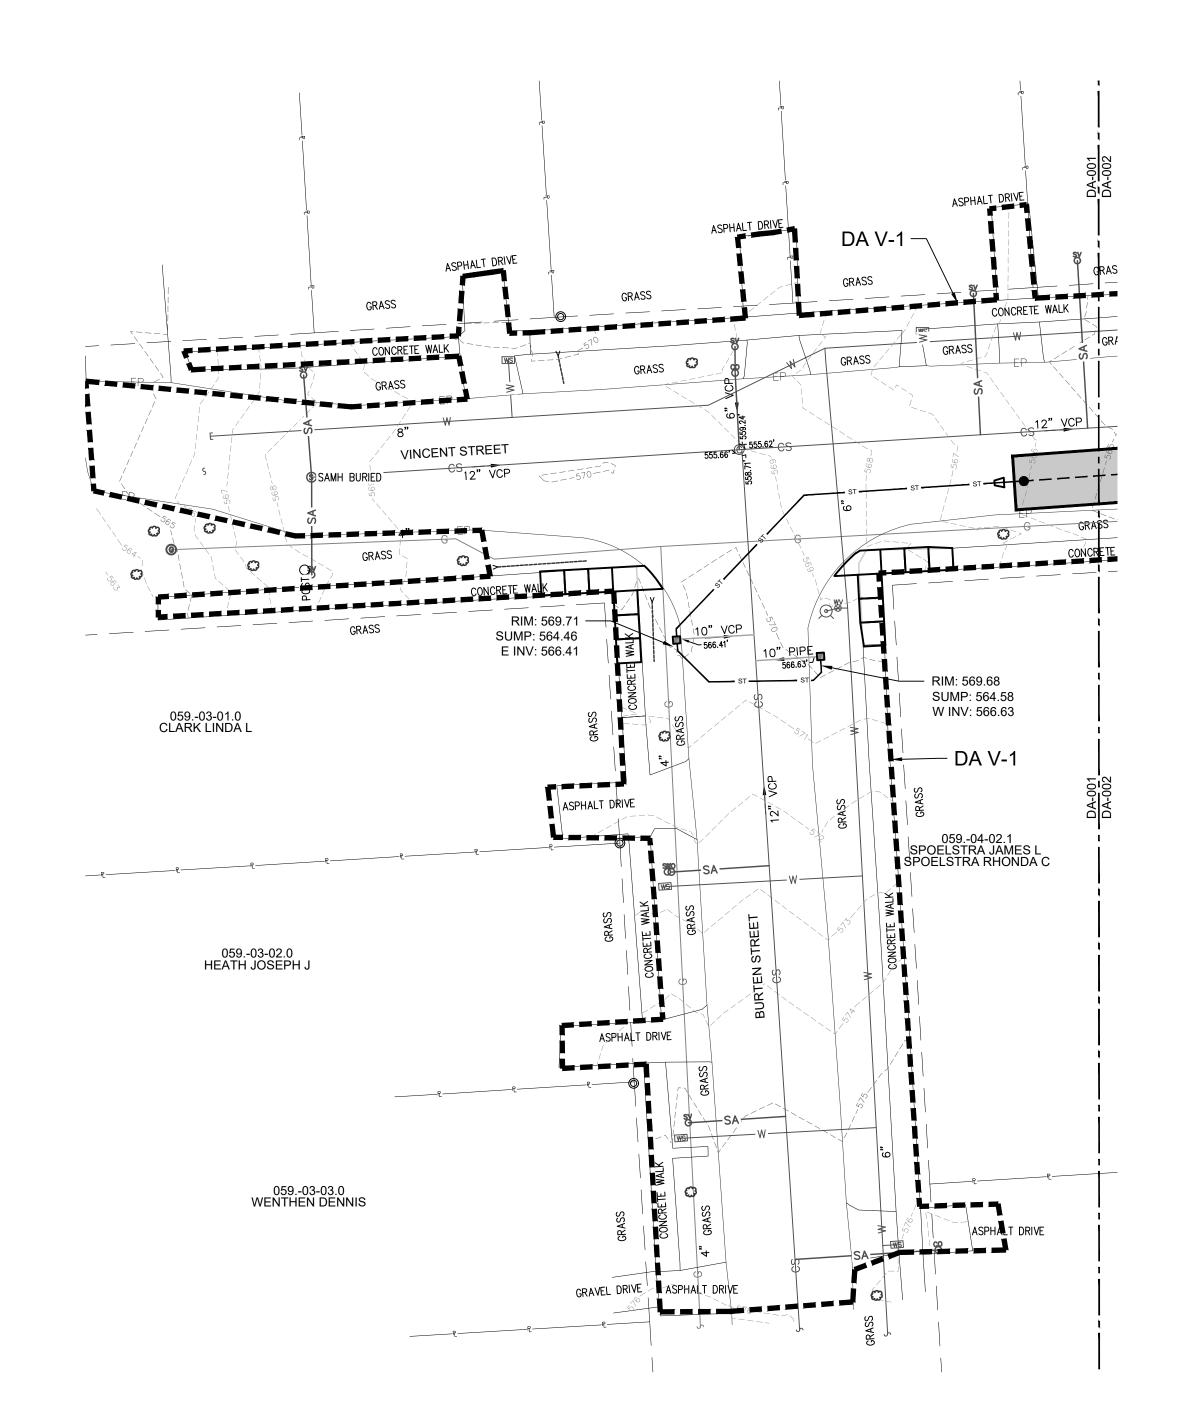

LEGEND		
ITEM	SYMBOL	
INFILTRATION TRENCH		
DRAINAGE AREA		
NEW CATCH BASIN	IIII	

INFILTRATION DRAINAGE AREAS				
PRACTICE	REQUIRED GI AREA (SQFT)	DRAINAGE AREA (SQFT)	LOADING RATIO	
INF V-1	2,040	27,005	13	

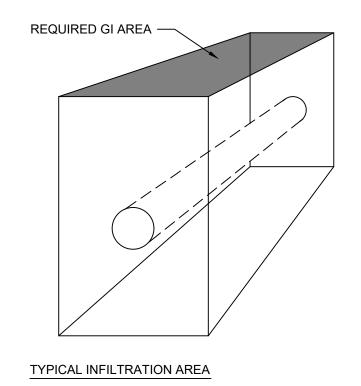



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TO OCDWEP	The following is paraphrased from the New York Education Law, Article 145, Section 7209, and Chapter II, Section	ew York Education pter II, Section
OCDWEP	79-1.4, and applies to this drawing: "It is a violation of this law for any person unless he is acting under the direction of a licensed professional and inches a licensed professional and inches and landscape."	a violation of this ider the direction of
) OCDWEP	architect or licensed land surveyor to alter an item in any way. If an item bearing the seal of an engineer, landscape	er an item in any gineer, landscape
O OCDWEP	architect or land surveyor is altered, the altering engineer, landscape architect or land surveyor shall affix to the item his good and the protetion "altered by" followed by his	altering engineer, Il affix to the item
	signature and the date of such alteration and a specific description of the alteration".	and a specific
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STREE" **119 GREEN**


ONONDAGA COUNTY SOW


UNDAGA COUNTY WATER ENVIRONMENT PROTECT E DRAINAGE AREA MAP

DATE: **5/14/2020** SCALE: 1"=20' EDR Job#: 19008 DRAWN BY: BL FILE NAME: VINCENT STREET

DRAWING NUMBER: DA-001


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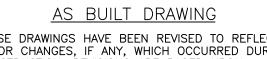


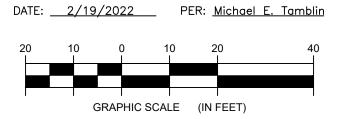

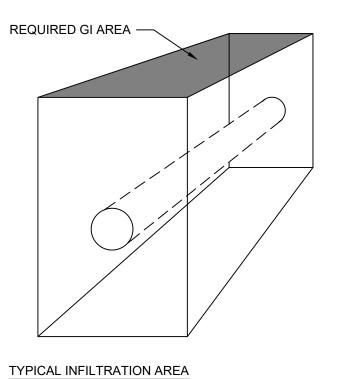
LEGEND		
ITEM SYMBOL		
INFILTRATION TRENCH		
DRAINAGE AREA		
NEW CATCH BASIN		


INFILTRATION DRAINAGE AREAS				
PRACTICE	REQUIRED GI AREA (SQFT)	DRAINAGE AREA (SQFT)	LOADING RATIO	
INF V-1	2,040	27,005	13	
INF V-2	1,188	16,671	14	



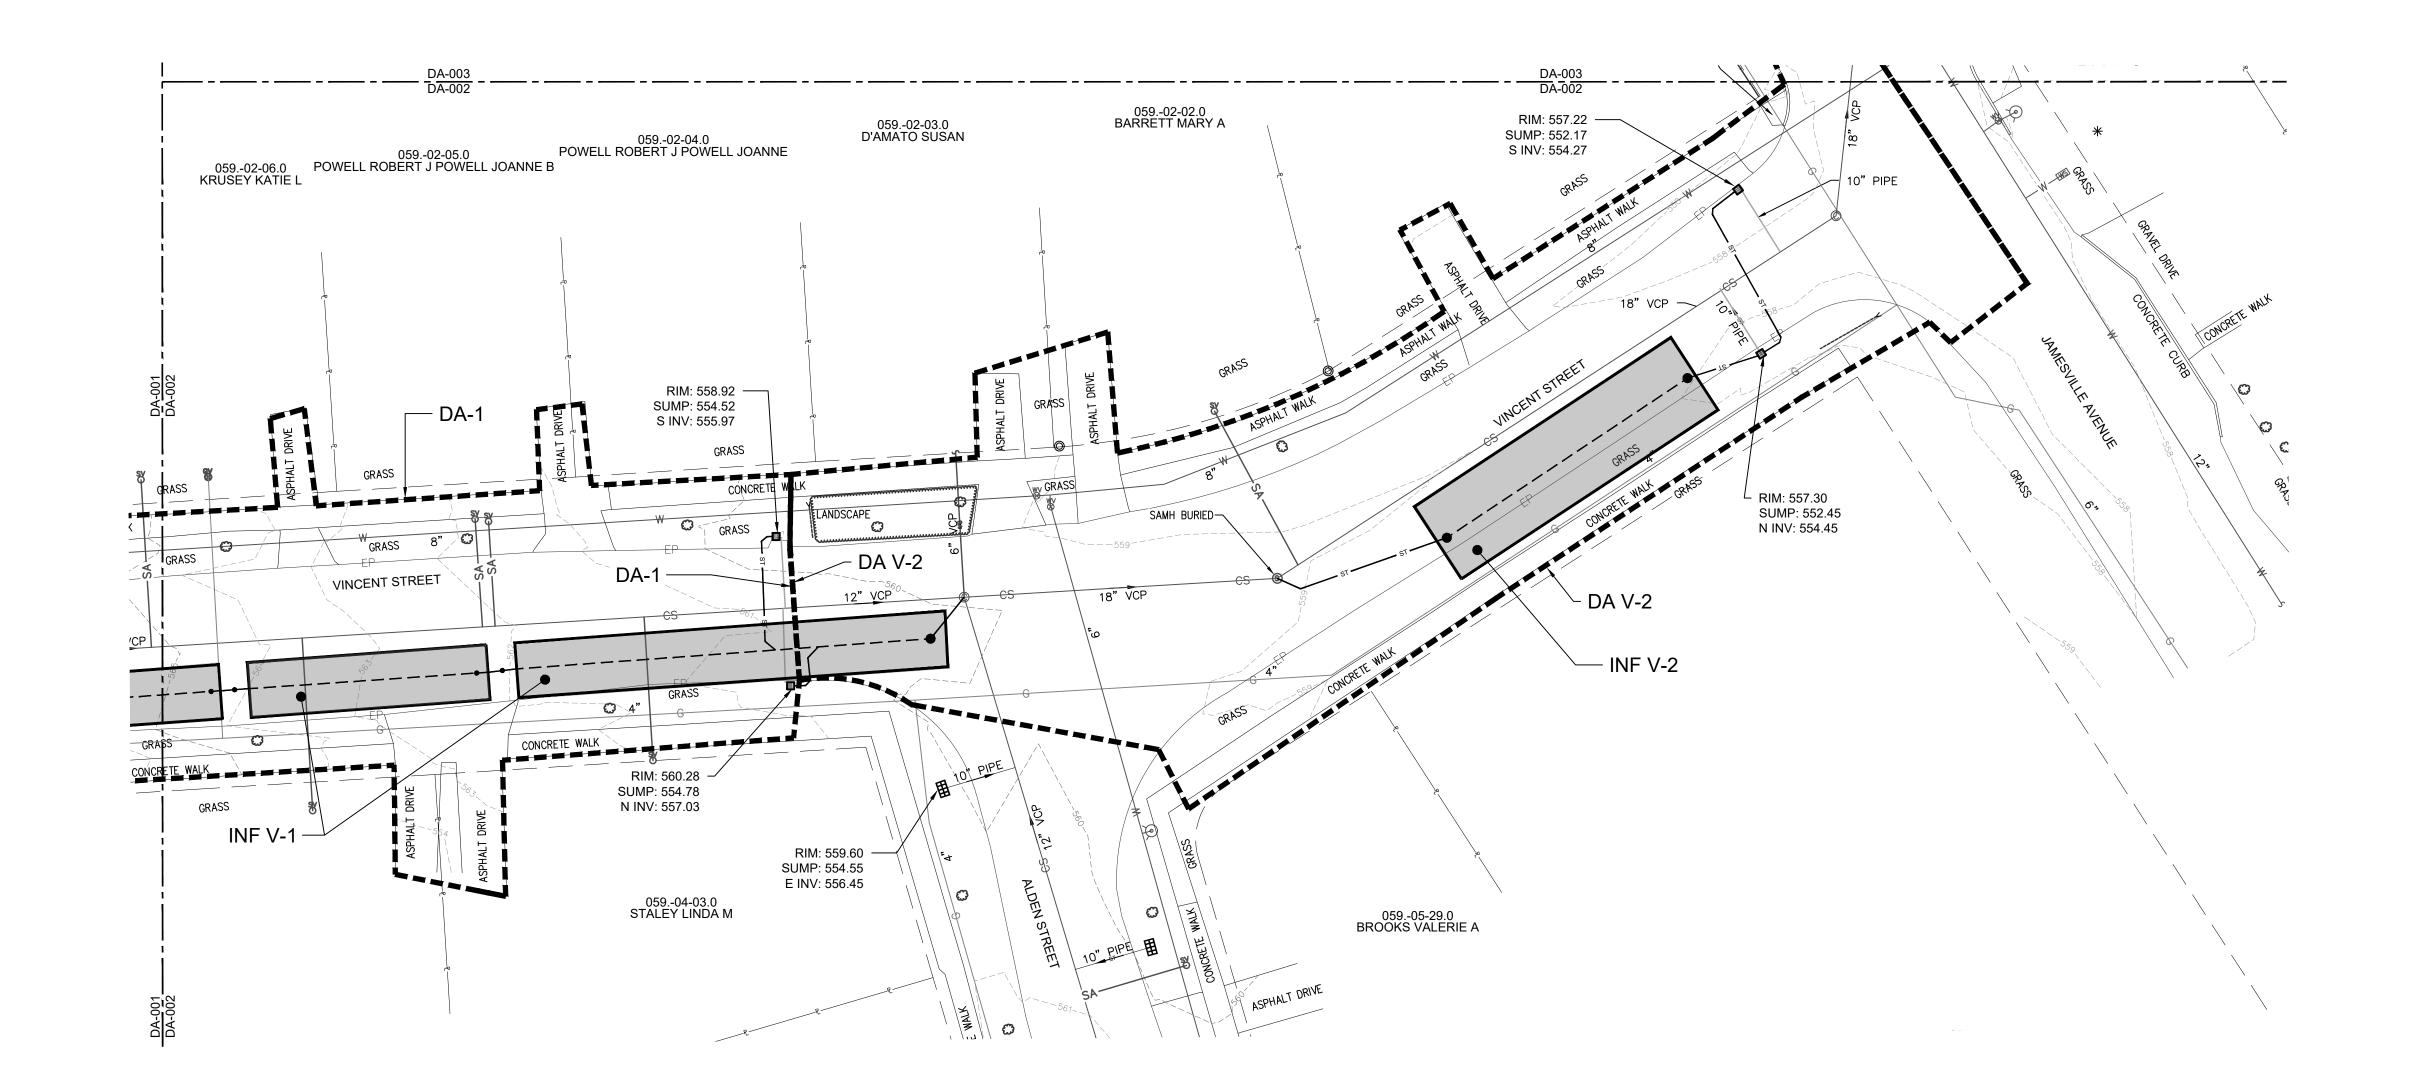

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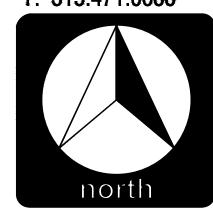


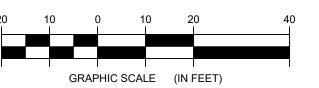

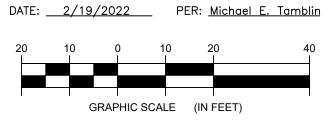

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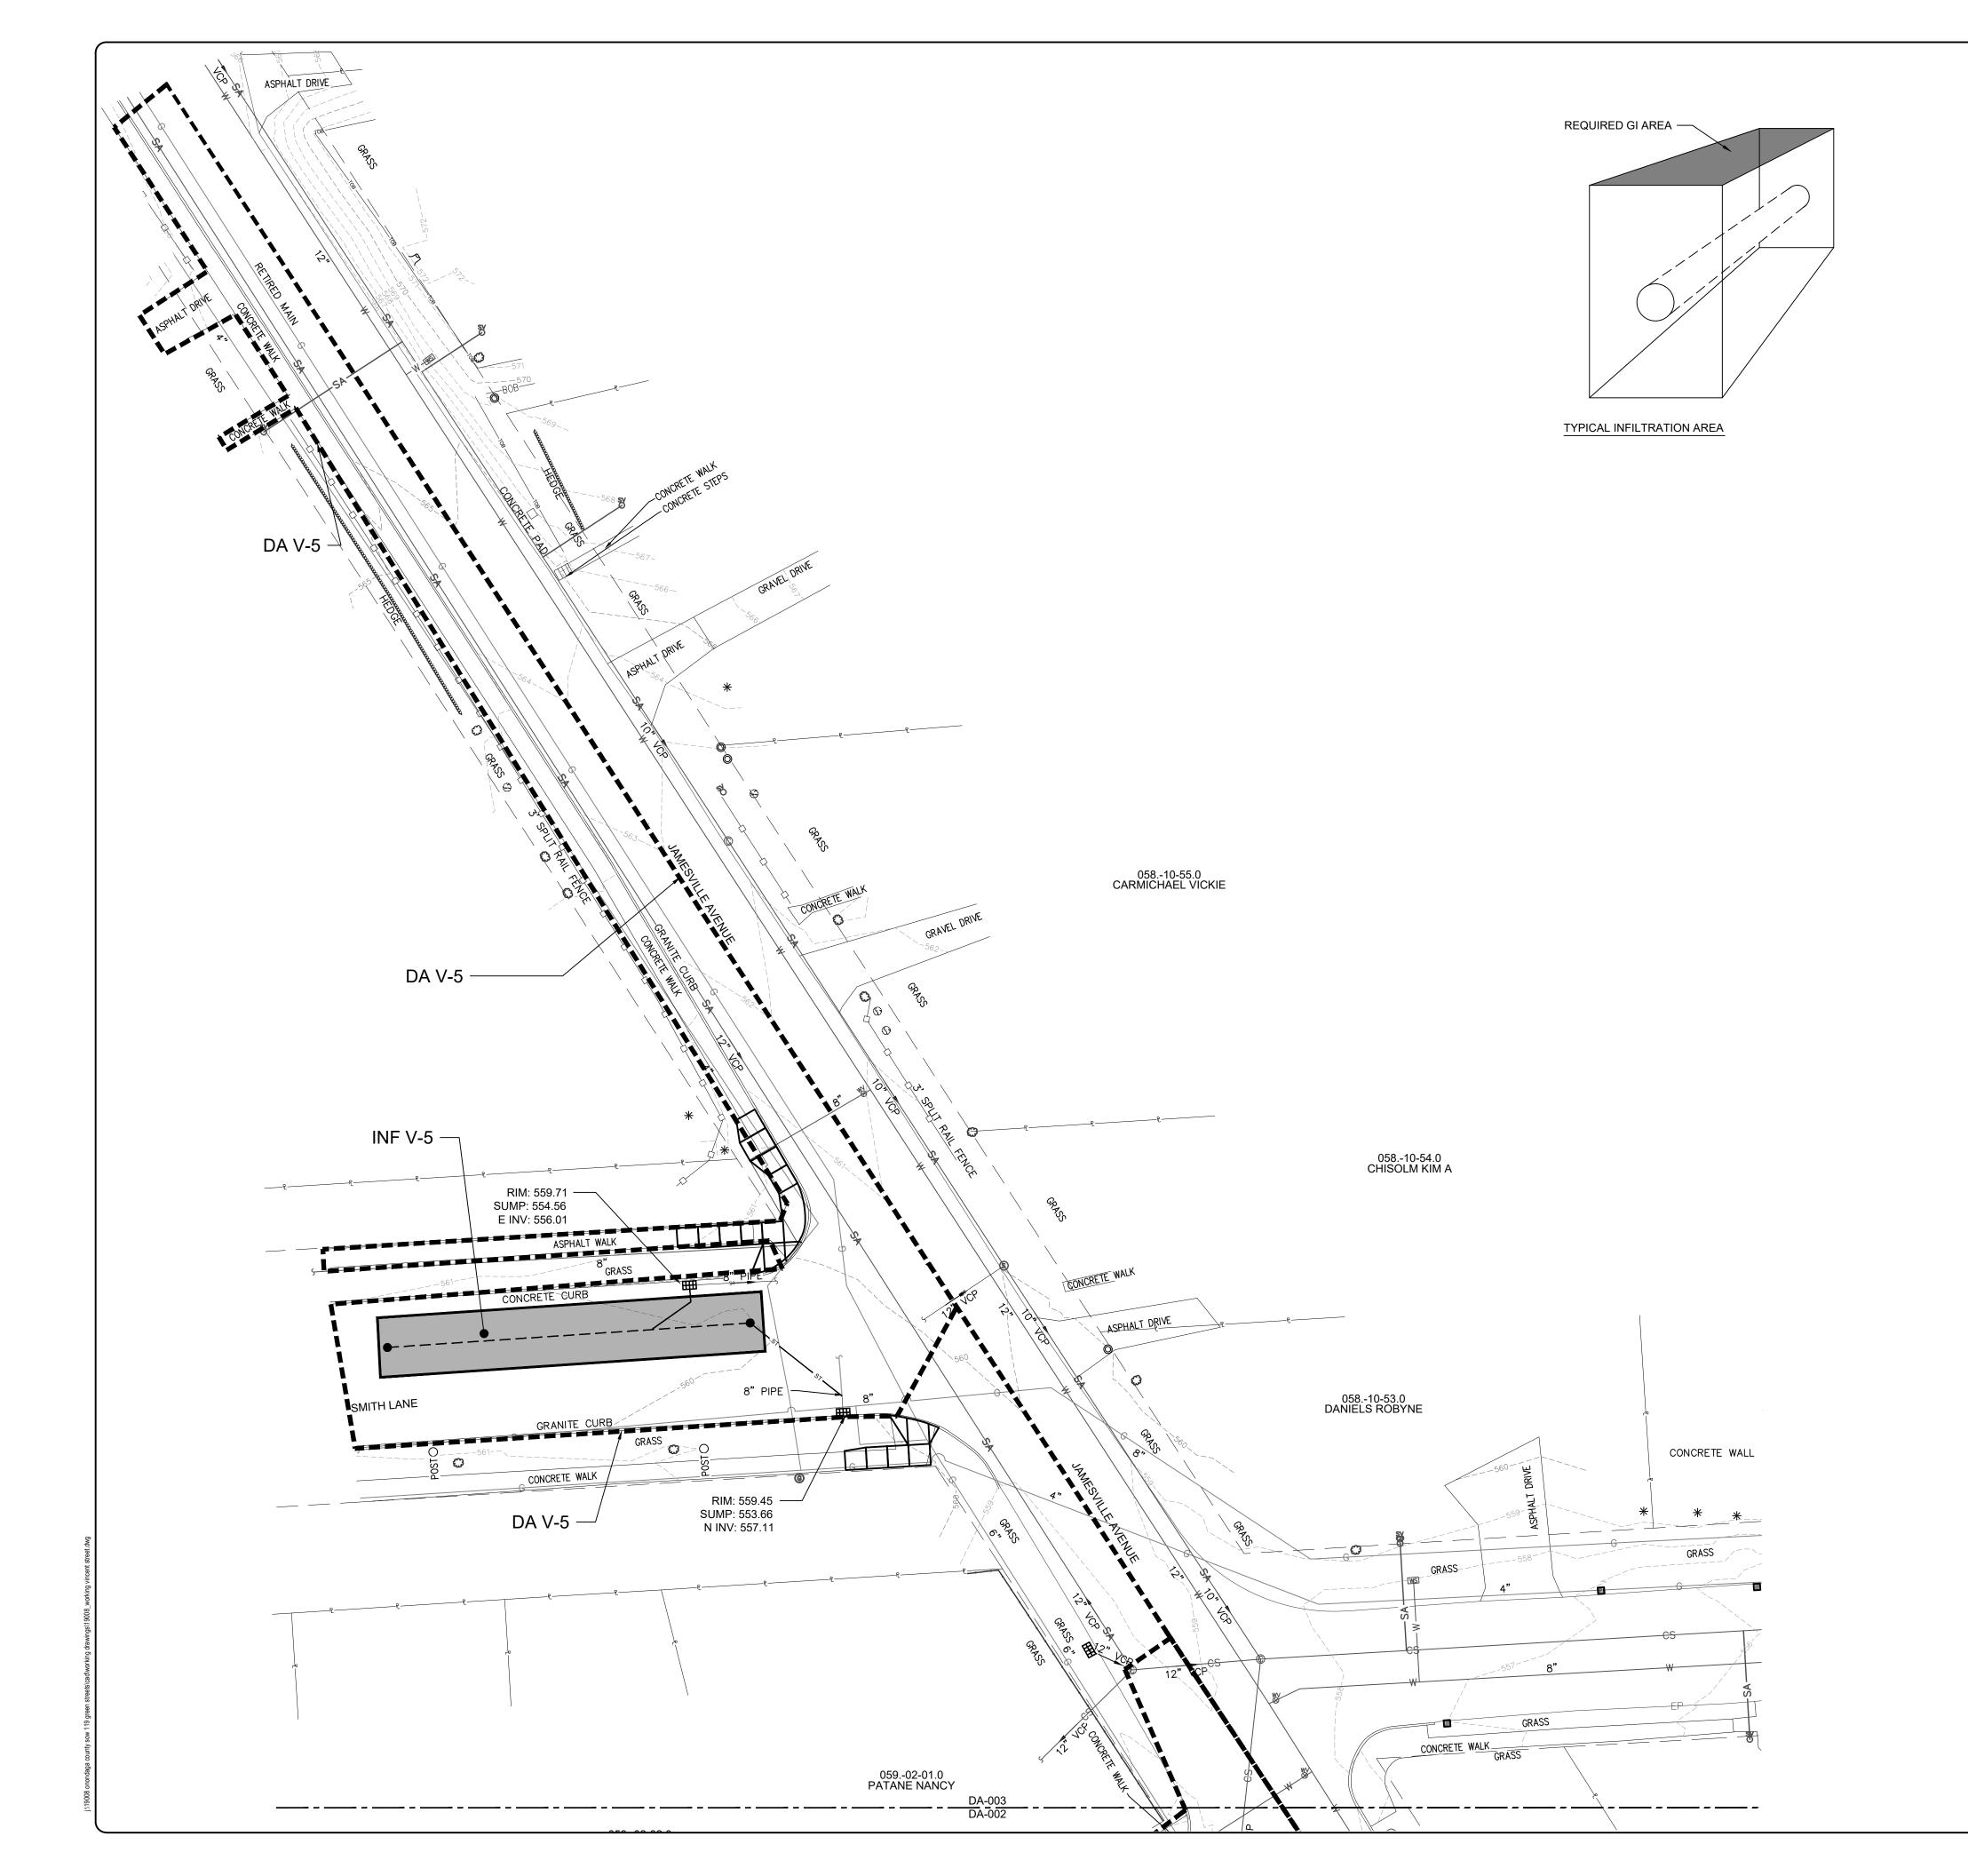
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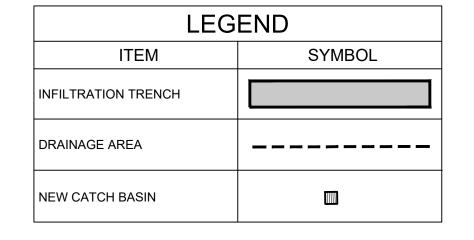
ONONDAGA COU ONONDAGA COUNTY WATER ENVIRO E DRAINAGE AREA MAI

<u> </u>	
	DATE: 5/14/2020
	SCALE: 1"=20'
	EDR Job#: 19008
	DRAWN BY: BL

VINCENT STREET

DRAWING NUMBER: DA-002





INFILTRATION DRAINAGE AREAS						
PRACTICE	REQUIRED GI AREA (SQFT)	DRAINAGE AREA (SQFT)	LOADING RATIO			
INF V-5	1,260	11,425	9			



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	DRAWING REVISIONS		
NO.	DATE	REVISION	ВУ
$\langle \wp \rangle$	10/4/19	50% RESUBMITTAL TO OCDWEP	
4	1/1/2020	90% SUBMITTAL TO OCDWEP	
\$	4/28/2020	100% SUBMITTAL TO OCDWEP	
\bigvee	5/14/2020	FINAL SUBMITTAL TO OCDWEP	
\forall	2/19/2022	2/19/2022 AS BUILT	
L			

COUNTY SOW 119 GREEN STREETS, SYRACUSE, NY
ENVIRONMENT PROTECTION

ECT LOCATION: VINCENT STREET, SYRACUSE, NY
T: ONONDAGA COUNTY WATER ENVIRONMENT PR

DATE: 5/14/2020

SCALE: 1"=20'

EDR Job#: 19008

DRAWN BY: BL

FILE NAME:

VINCENT STREET

DRAWING NUMBER:

DA-003


DATE: 2/19/2022 PER: Michael E. Tamblin

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GRAPHIC SCALE (IN FEET)


AS BUILT DRAWING

THESE DRAWINGS HAVE BEEN REVISED TO REFLECT MAJOR CHANGES, IF ANY, WHICH OCCURRED DURING CONSTRUCTION. REVISIONS ARE BASED UPON INFORMATION SUPPLIED BY CONTRACTOR.

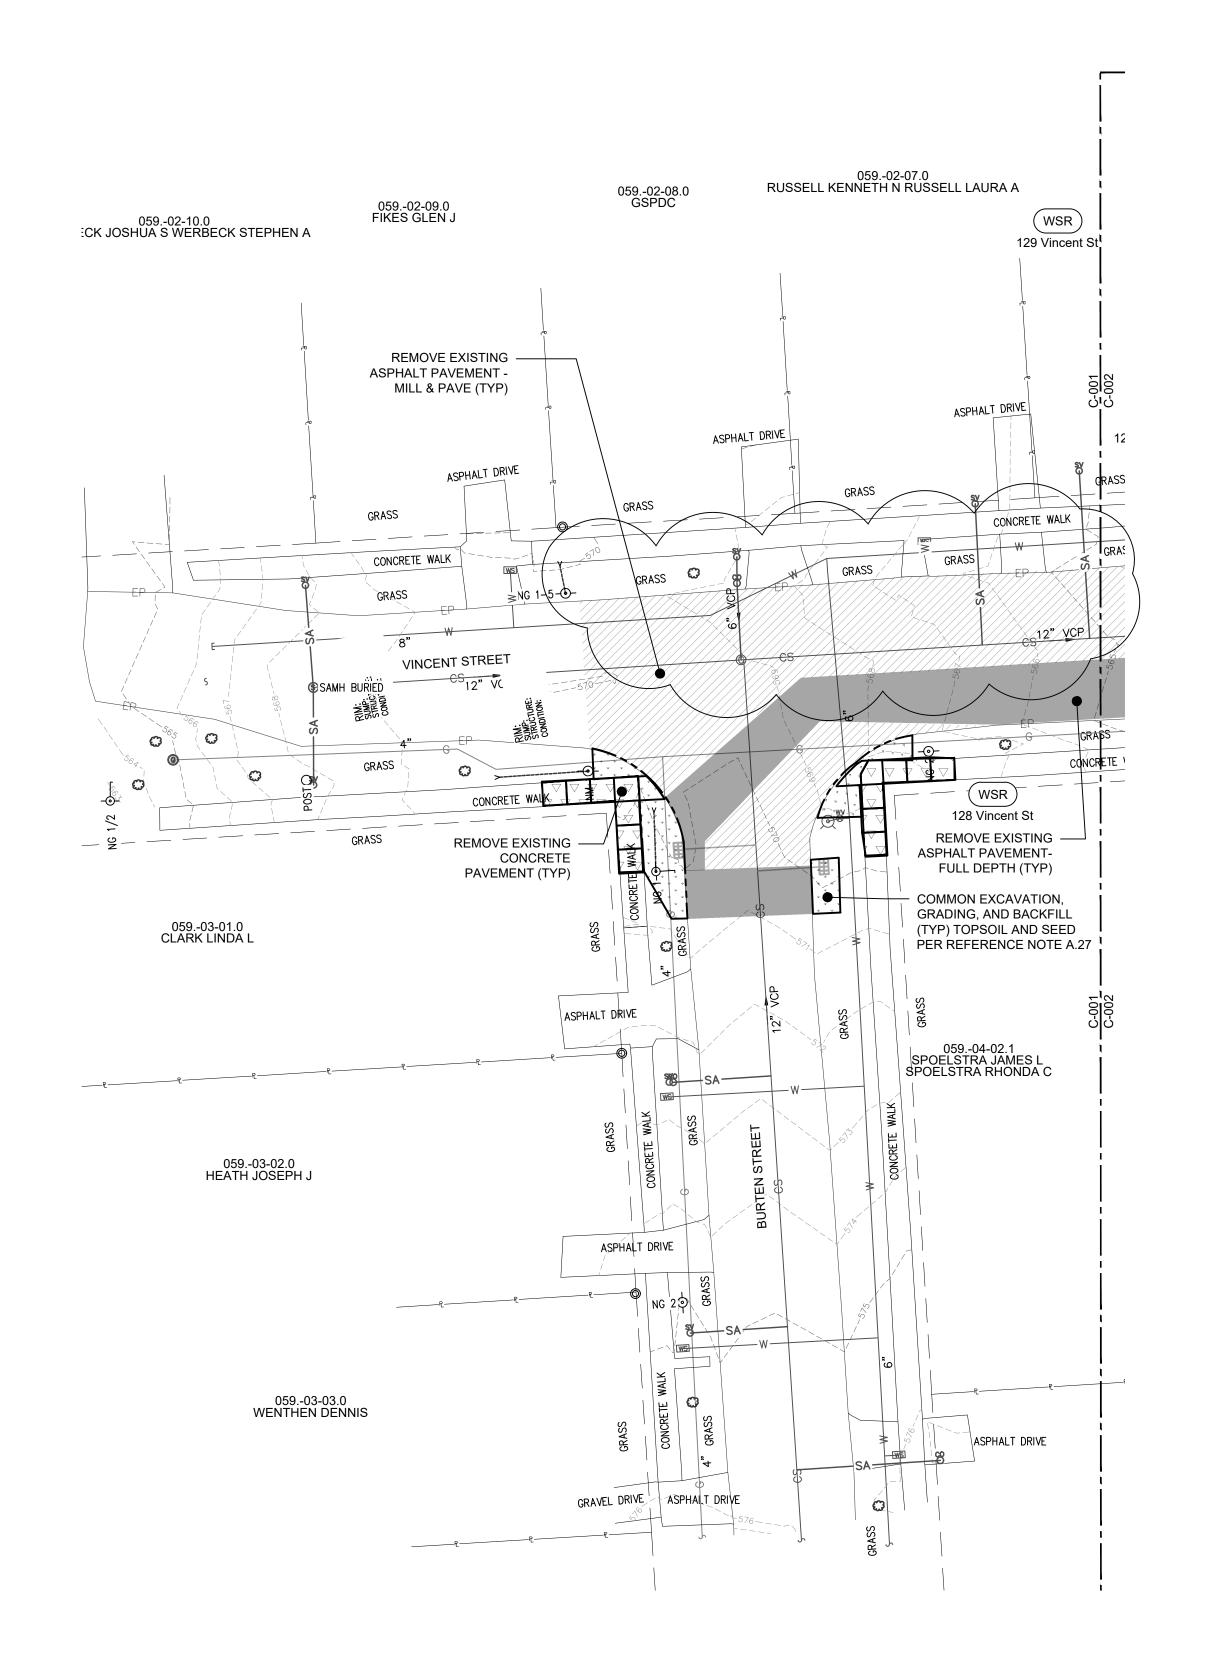

DEMOLITION LEGEND					
ITEM	SYMBOL	PAY ITEM			
REMOVE EXISTING ASPHALT PAVEMENT - MILL 2" & PAVE 2" WITH REQUIRED SAWCUTS	·/////////////////////////////////////	1.4			
REMOVE EXISTING CONCRETE PAVEMENT TO NEXT PANEL IN GOOD CONDITION AT JOINT		1.3			
REMOVE EXISTING ASPHALT PAVEMENT - FULL DEPTH WITH REQUIRED SAWCUTS		1.3			
REMOVE EXISTING CURB					
COMMON EXCAVATION & GRADING - TOPSOIL AND SEED PER REFERENCE NOTE A.27		1.5B			
WATER SERVICE REPLACEMENT	WSR	1.52B			
PROTECT EXISTING VEGETATION	VP VP VP	1.58			
REMOVE EXISTING TREE	×				

NOTE: CONTRACTOR SHALL MILL 0'-2" OF EXISTING PAVEMENT AS SHOWN FOR MILLING AND OR REMOVAL PRIOR TO ANY PIPE TRENCH EXCAVATION BEING PERFORMED.

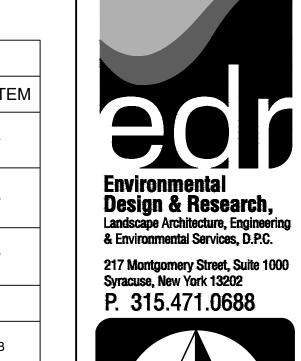




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50% RESUBMITTAL TO OCDWEP	
90% SUBMITTAL TO OCDWEP	
4/28/2020 100% SUBMITTAL TO OCDWEP	
FINAL SUBMITTAL TO OCDWEP	

THE ONONDAGA COUNTY SOW 119 GREEN STREETS	OCATION: VINCENT STREET, SYRACUSE, NY	NONDAGA COUNTY WATER ENVIRONMENT PROTECTION	THE EXISTING CONDITIONS AND DEMOLITION PLAN
E. ONONDAGA COUNTY SOW 119	ATION: VINCENT STREET, SYRACUSE, NY	NDAGA COUNTY WATER ENVIRONMENT PROTECTION	EXISTING CONDITIONS AND DEMOLITIC

	DATE: 5/14/2020
	SCALE: 1"=20'
	EDR Job#: 19008
	DRAWN BY: BL
0	FILE NAME: VINCENT STREET
	DRAWING NUMBER:
 	C-001

AS BUILT DRAWING THESE DRAWINGS HAVE BEEN REVISED TO REFLECT MAJOR CHANGES, IF ANY, WHICH OCCURRED DURING CONSTRUCTION. REVISIONS ARE BASED UPON INFORMATION SUPPLIED BY CONTRACTOR. DATE: <u>2/19/2022</u> PER: <u>Michael E. Tamblin</u>

GRAPHIC SCALE (IN FEET)

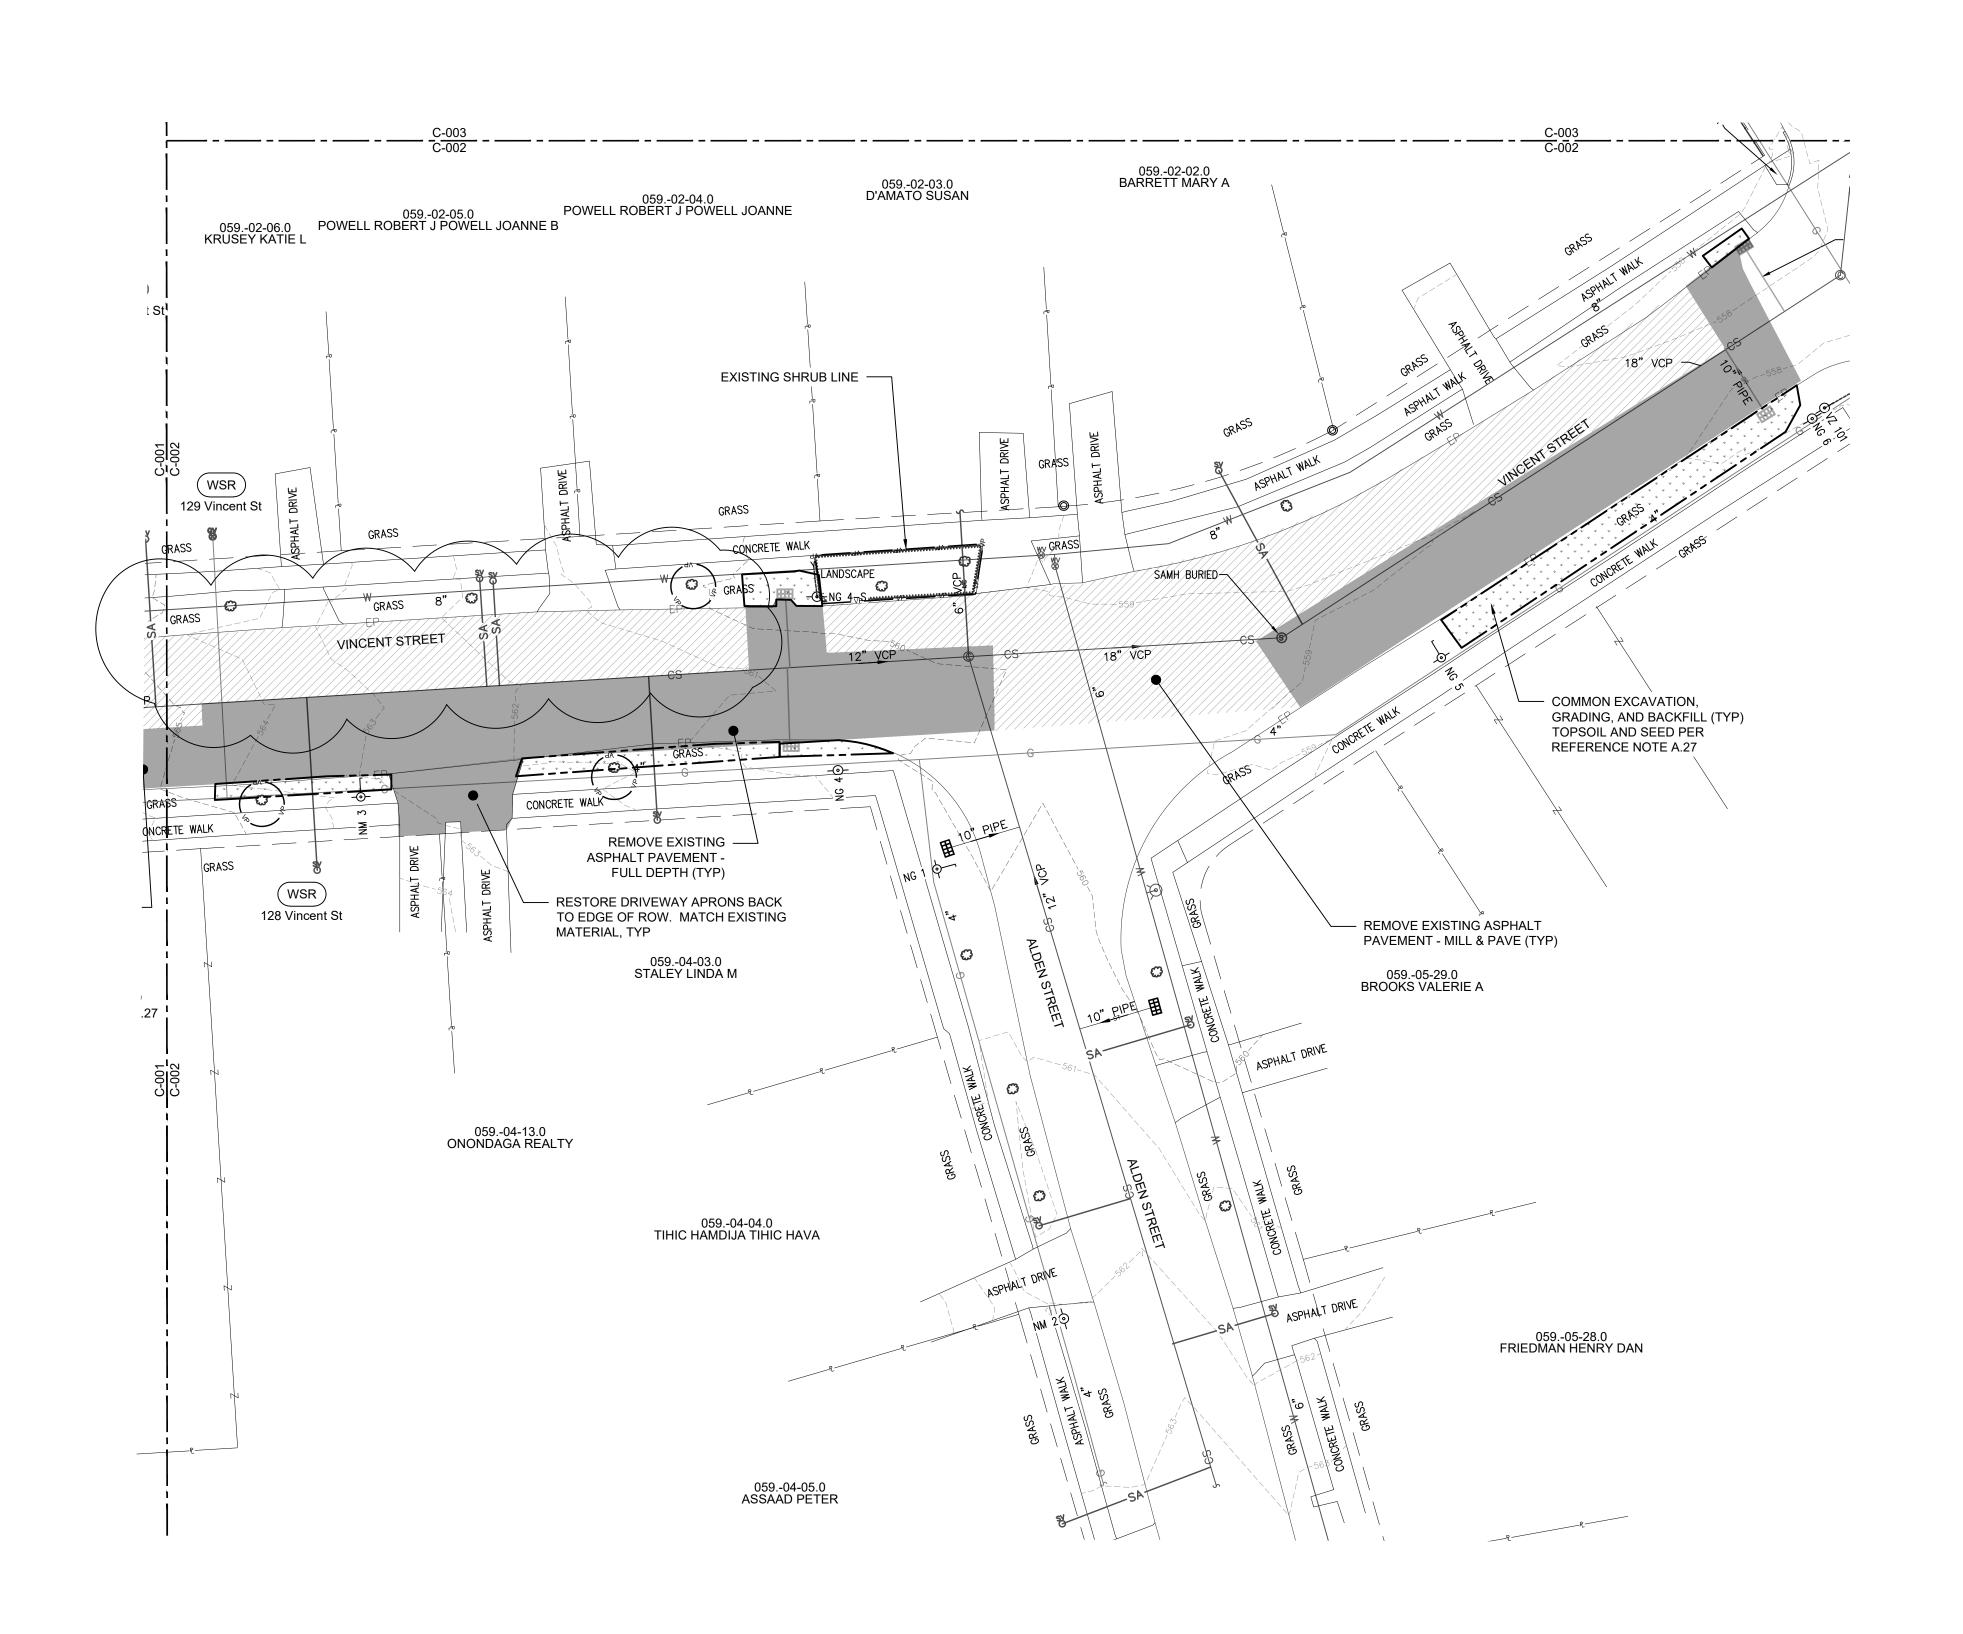

DEMOLITION LEGEND					
ITEM	SYMBOL	PAY ITEM			
REMOVE EXISTING ASPHALT PAVEMENT - MILL 2" & PAVE 2" WITH REQUIRED SAWCUTS	·/////////////////////////////////////	1.4			
REMOVE EXISTING CONCRETE PAVEMENT TO NEXT PANEL IN GOOD CONDITION AT JOINT		1.3			
REMOVE EXISTING ASPHALT PAVEMENT - FULL DEPTH WITH REQUIRED SAWCUTS		1.3			
REMOVE EXISTING CURB					
COMMON EXCAVATION & GRADING - TOPSOIL AND SEED PER REFERENCE NOTE A.27		1.5B			
WATER SERVICE REPLACEMENT	WSR	1.52B			
PROTECT EXISTING VEGETATION	VP VP VP	1.58			
REMOVE EXISTING TREE	×				

NOTE: CONTRACTOR SHALL MILL 0'-2" OF EXISTING PAVEMENT AS SHOWN FOR MILLING AND OR REMOVAL PRIOR TO ANY PIPE TRENCH EXCAVATION BEING PERFORMED.

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	ВУ					
SNOISIA	REVISION	50% RESUBMITTAL TO OCDWEP	90% SUBMITTAL TO OCDWEP	100% SUBMITTAL TO OCDWEP	FINAL SUBMITTAL TO OCDWEP	AS BUILT
DRAWING REVISIONS	DATE	10/4/19	1/1/2020	4/28/2020	5/14/2020	2/19/2022
	NO.	€	4	3	(

STATUE ON ONDAGA COUNTY SOW TIS GREEN STREET	ST LOCATION: VINCENT STREET, SYRACUSE, NY	ONONDAGA COUNTY WATER ENVIRONMENT PROTECTION
ST TITLE: ONO	ST LOCATION: VINC	ONONDAGA CC

DATE: 5/14/2020

C-002

EXISTING CONDITIONS AND DEMOLITION PLAN

THESE DRAWINGS HAVE BEEN REVISED TO REFLECT MAJOR CHANGES, IF ANY, WHICH OCCURRED DURING	EDR Job#: 19008
CONSTRUCTION. REVISIONS ARE BASED UPON INFORMATION SUPPLIED BY CONTRACTOR.	DRAWN BY: BL
DATE: <u>2/19/2022</u> PER: <u>Michael E. Tamblin</u> 20 10 0 10 20 40	FILE NAME: VINCENT STREET
	DRAWING NUMBER:
GRAPHIC SCALE (IN FEET)	C-002

<u>AS BUILT DRAWING</u>

	ITEM S	SYMBOL	PAY ITEM
	REMOVE EXISTING ASPHALT PAVEMENT - MILL 2" & PAVE 2" WITH REQUIRED SAWCUTS		1.4
	REMOVE EXISTING CONCRETE PAVEMENT TO NEXT PANEL IN GOOD CONDITION AT JOINT	7	1.3
	REMOVE EXISTING ASPHALT PAVEMENT - FULL DEPTH WITH REQUIRED SAWCUTS		1.3
	REMOVE EXISTING CURB ————		
			1.5B
	WATER SERVICE REPLACEMENT	WSR	1.52B
	PROTECT EXISTING	_ VP VP	1.58
	REMOVE EXISTING TREE	×	
Section 1 Section 21	NOTE: CONTRACTOR SHALL MILL 0'-2" OF EXIST MILLING AND OR REMOVAL PRIOR TO ANY PIPE PERFORMED.	ING PAVEMENT AS SH TRENCH EXCAVATION	HOWN FOR N BEING
CASOLITE TO THE STATE OF THE ST	NM 1219 OSS12-22.0 MOSHER RACHEL E		
OTE OSB10-55.0 CARMICHAEL VICKIE	JACQUES ROBERT M SA SS S		

058.-10-54.0 CHISOLM KIM A

058.-10-53.0 DANIELS ROBYNE

CONCRETE WALK GRASS

ASPHALT DRIVE

REMOVE EXISTING CURB -

SMITH LANE

(🖒

ASPHALT WALK

GRANITE CURB

0E0 02 02 0

REMOVE EXISTING CURB —

059.-02-01.0 PATANE NANCY

CONCRETE WALK

058.-10-50.0 SHIELDS WILLIAM M

058.-10-51.0 HYLAND KIMBERLY D

058.-10-52.0 TAMOUTSELIS ATHANASIOS BARLOW BELINDA

VINCENT STREET

10" VCP —

ASPHALT WALK

CONCRETE WALL

ASPHALT DRIVE

CONCRETE WALK

 \odot

ASPHALT WALK

AS BUILT DRAWING

THESE DRAWINGS HAVE BEEN REVISED TO REFLECT MAJOR CHANGES, IF ANY, WHICH OCCURRED DURING CONSTRUCTION. REVISIONS ARE BASED UPON INFORMATION SUPPLIED BY CONTRACTOR.

DATE: 2/19/2022 PER: Michael E. Tamblin

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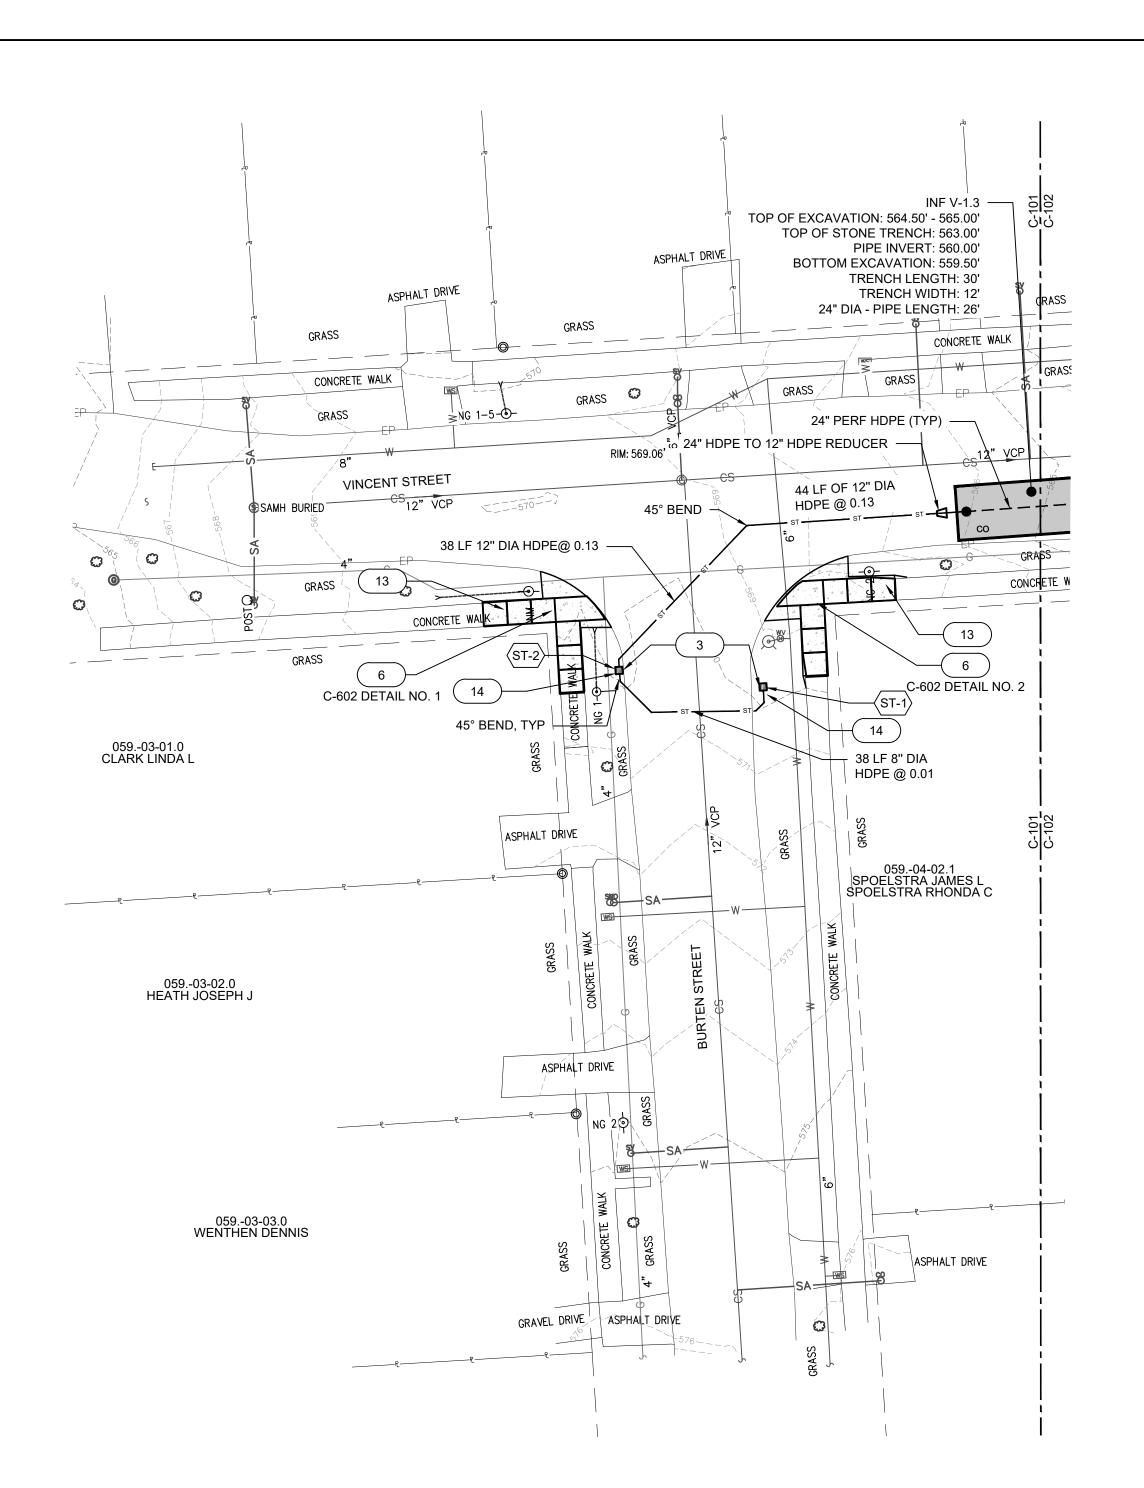
GRAPHIC SCALE (IN FEET)

S S EXISTING CONDITIONS AND DEMOLITION PLAN 119 COUNTY ONONDAGA DATE: 5/14/2020 SCALE: 1"=20' EDR Job#: 19008 DRAWN BY: BL FILE NAME: VINCENT STREET DRAWING NUMBER: C-003

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north



REFERENCE NOTES

MAINTAIN 18" SEPARATION BETWEEN TOP OF WATERLINE AND BOTTOM OF INFILTRATION PRACTICE OR STORM LINE. IF 18" VERTICAL SEPARATION CANNOT BE ACHIEVED, ENCASE THE NEW PIPE IN CONCRETE PER DETAIL PS-21

COORDINATE WITH NATIONAL GRID ON GAS LINE CROSSINGS.

DISCONNECT CATCH BASIN FROM SEWER. SEE DETAILS ON SHEET C-601. FIELD VERIFY PIPE SLOPES AND INVERTS OF CONNECTING STRUCTURES PRIOR TO ALL WORK.

VERIFY PIPE SLOPE AND INVERT OF CONNECTING STRUCTURE IN FIELD.

DIRECT CONNECTION TO EXISTING SEWER PER DETAIL 5 DR.17. FIELD VERIFY PIPE SLOPES AND INVERTS OF CONNECTING STRUCTURES PRIOR TO ALL WORK.

6 REPAIR ADA CURB RAMP - DETAIL PS.13. TYPE: 10'-0" WIDE

INSTALL IN-LINE BACKFLOW PREVENTER. 7) TIDEFLEX CHECKMATE INLINE CHECK VALVE MATCHING OUTLET PIPE SIZE AND FLOW DIRECTION.

MAINTAIN 2'-0" MIN SEPARATION BETWEEN INFILTRATION TRENCH AND GAS LINE/COMBINED SEWER

INFILTRATION TRENCH SHALL BE CONSTRUCTED AT A MINIMUM DISTANCE OF 5'-0" FROM UTILITY POLE

NATIONAL GRID RELOCATING GAS OUT OF THE (10) ROAD

11 DETAIL IS.05 12) MATCH WIDTH OF EXISTING SIDEWALK (5' MINIMUM)

EARTHEN BERM BETWEEN INFILTRATION TRENCHES.

ALL ASPHALT AND CONCRETE WALKS REMOVED ON 13) DEMOLITION PLAN SHALL BE REPLACED WITH CITY OF SYRACUSE STANDARD CONCRETE WALKS

GRADE/PAVE TO ENSURE POSITIVE DRAINAGE TO CATCH BASINS ON UNIMPROVED STREETS


INF V-1.1, INF V-1.2, AND INF V-1.3 ARE SIZED TO PROVIDE APPROXIMATELY 1 INCH OF STATIC-STORAGE VOLUME TO AVOID USING MULTIPLE UNDERDRAIN PIPES IN A SINGLE TRENCH.

	SITE PLAN LEGEND						
=	ITEM	SYMBOL	PAY ITEM	DETAIL			
	INFILTRATION TRENCH			IS.01			
5.	CONCRETE SIDEWALK		1.40A	PS.11			
	IMPERMEABLE LINER TRENCH SIDES ONLY	,,,,,,,,,,,,,,,,,,,,,,,,,,,,,,,,,,,,,,,	1.33				
	STORM CATCH BASIN		1.16A	DR.04			
	STORM MANHOLE	•	1.16D	DR.06			
	UNDERDRAIN		1.23B				
	STORM LINE	ST ST	SEE BELOW				
	CLEANOUT	•	1.27A	DR.14			
	ANTI-SEEP COLLAR ASC	ST ST	1.25	DR.16			
	CURB		1.35A & 1.35B	PS.14			

PIPE DIAMETER	PAY ITEM	PIPE DIAMETER	PAY ITE
3"	1.23B	8"	1.20A
10"	1.23C	10"	1.20B
12"	1.23D	12"	1.20C
5"	1.23E	15"	1.20D
18"	1.23F		
24"	1.23G		


GAS SERVICES SHALL BE WRAPPED PER DETAIL DR-23 ALL DISTURBED SIGNAGE SHALL BE RESET PER DETAIL TU.04

3. CONTRACTORS TO COORDINATE CONSTRUCTION WITH NATIONAL GRID

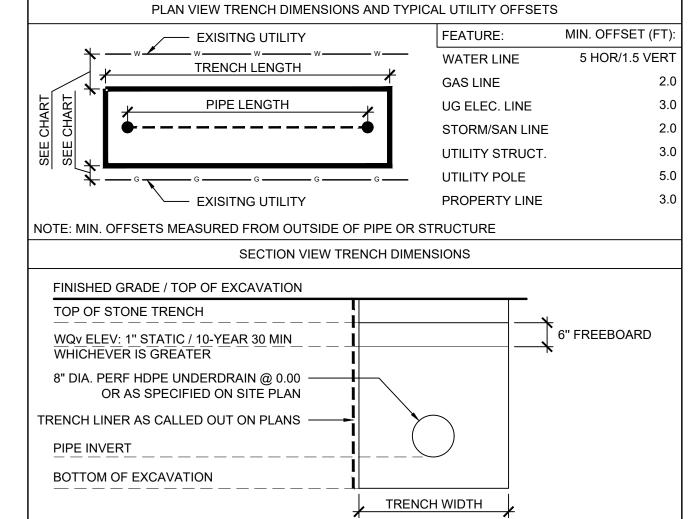

STRUCTURE JØ	RIM	INVERTS	<u> </u>	DESCRIPTION	DETAIL NO.	PAY ITEM N
31NOCTONE 10	IVIIVI	IIVVLINIS		DESCRIPTION	DETAIL NO.	TATTLEVIN
ST-1 /	569.87	NEW S INV: 566.96		NEW CATCH BASIN	DR.04	1.16A
[]		NEW SUMP: 565.00		WITH NEW SUMP		1.19A
ST-2	569.85	NEW S INV: 566.58		NEW CATCH BASIN	DR.04	1.16A
\ \ \ \		NEW N INV: 564.92		WITH NEW SUMP		1.19A
		NEW SUMP: 563.03)			
		11211 301111 : 303.03	1/			

FILTER INSERTS (PI 1.19A) ARE REQUIRED ON ALL NEW AND EXISTING GRATED STRUCTURES TRIBUTARY TO THE INFILTRATION TRENCHES ALL WEIRS TO HAVE 1" ORIFICE AT THE SAME INVERT ELEVATION AS OUTLET PIPES TO THE COMBINED SEWER

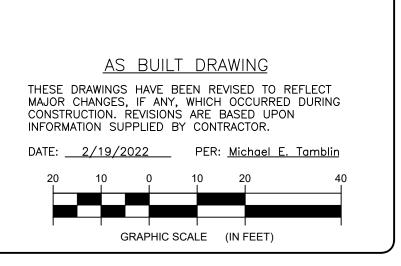



Design & Research, Landscape Architecture, Engineering & Environmental Services, D.P.C. 217 Montgomery Street, Suite 1000

Syracuse, New York 13202



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SIONS	REVISION	50% RESUBMITTAL TO OCDWEP	90% SUBMITTAL TO OCDWEP	100% SUBMITTAL TO OCDWEP	FINAL SUBMITTAL TO OCDWEP	AS BUILT	
DRAWING REVISIONS	DATE	10/4/19	1/1/2020	4/28/2020	5/14/2020	2/19/2022	
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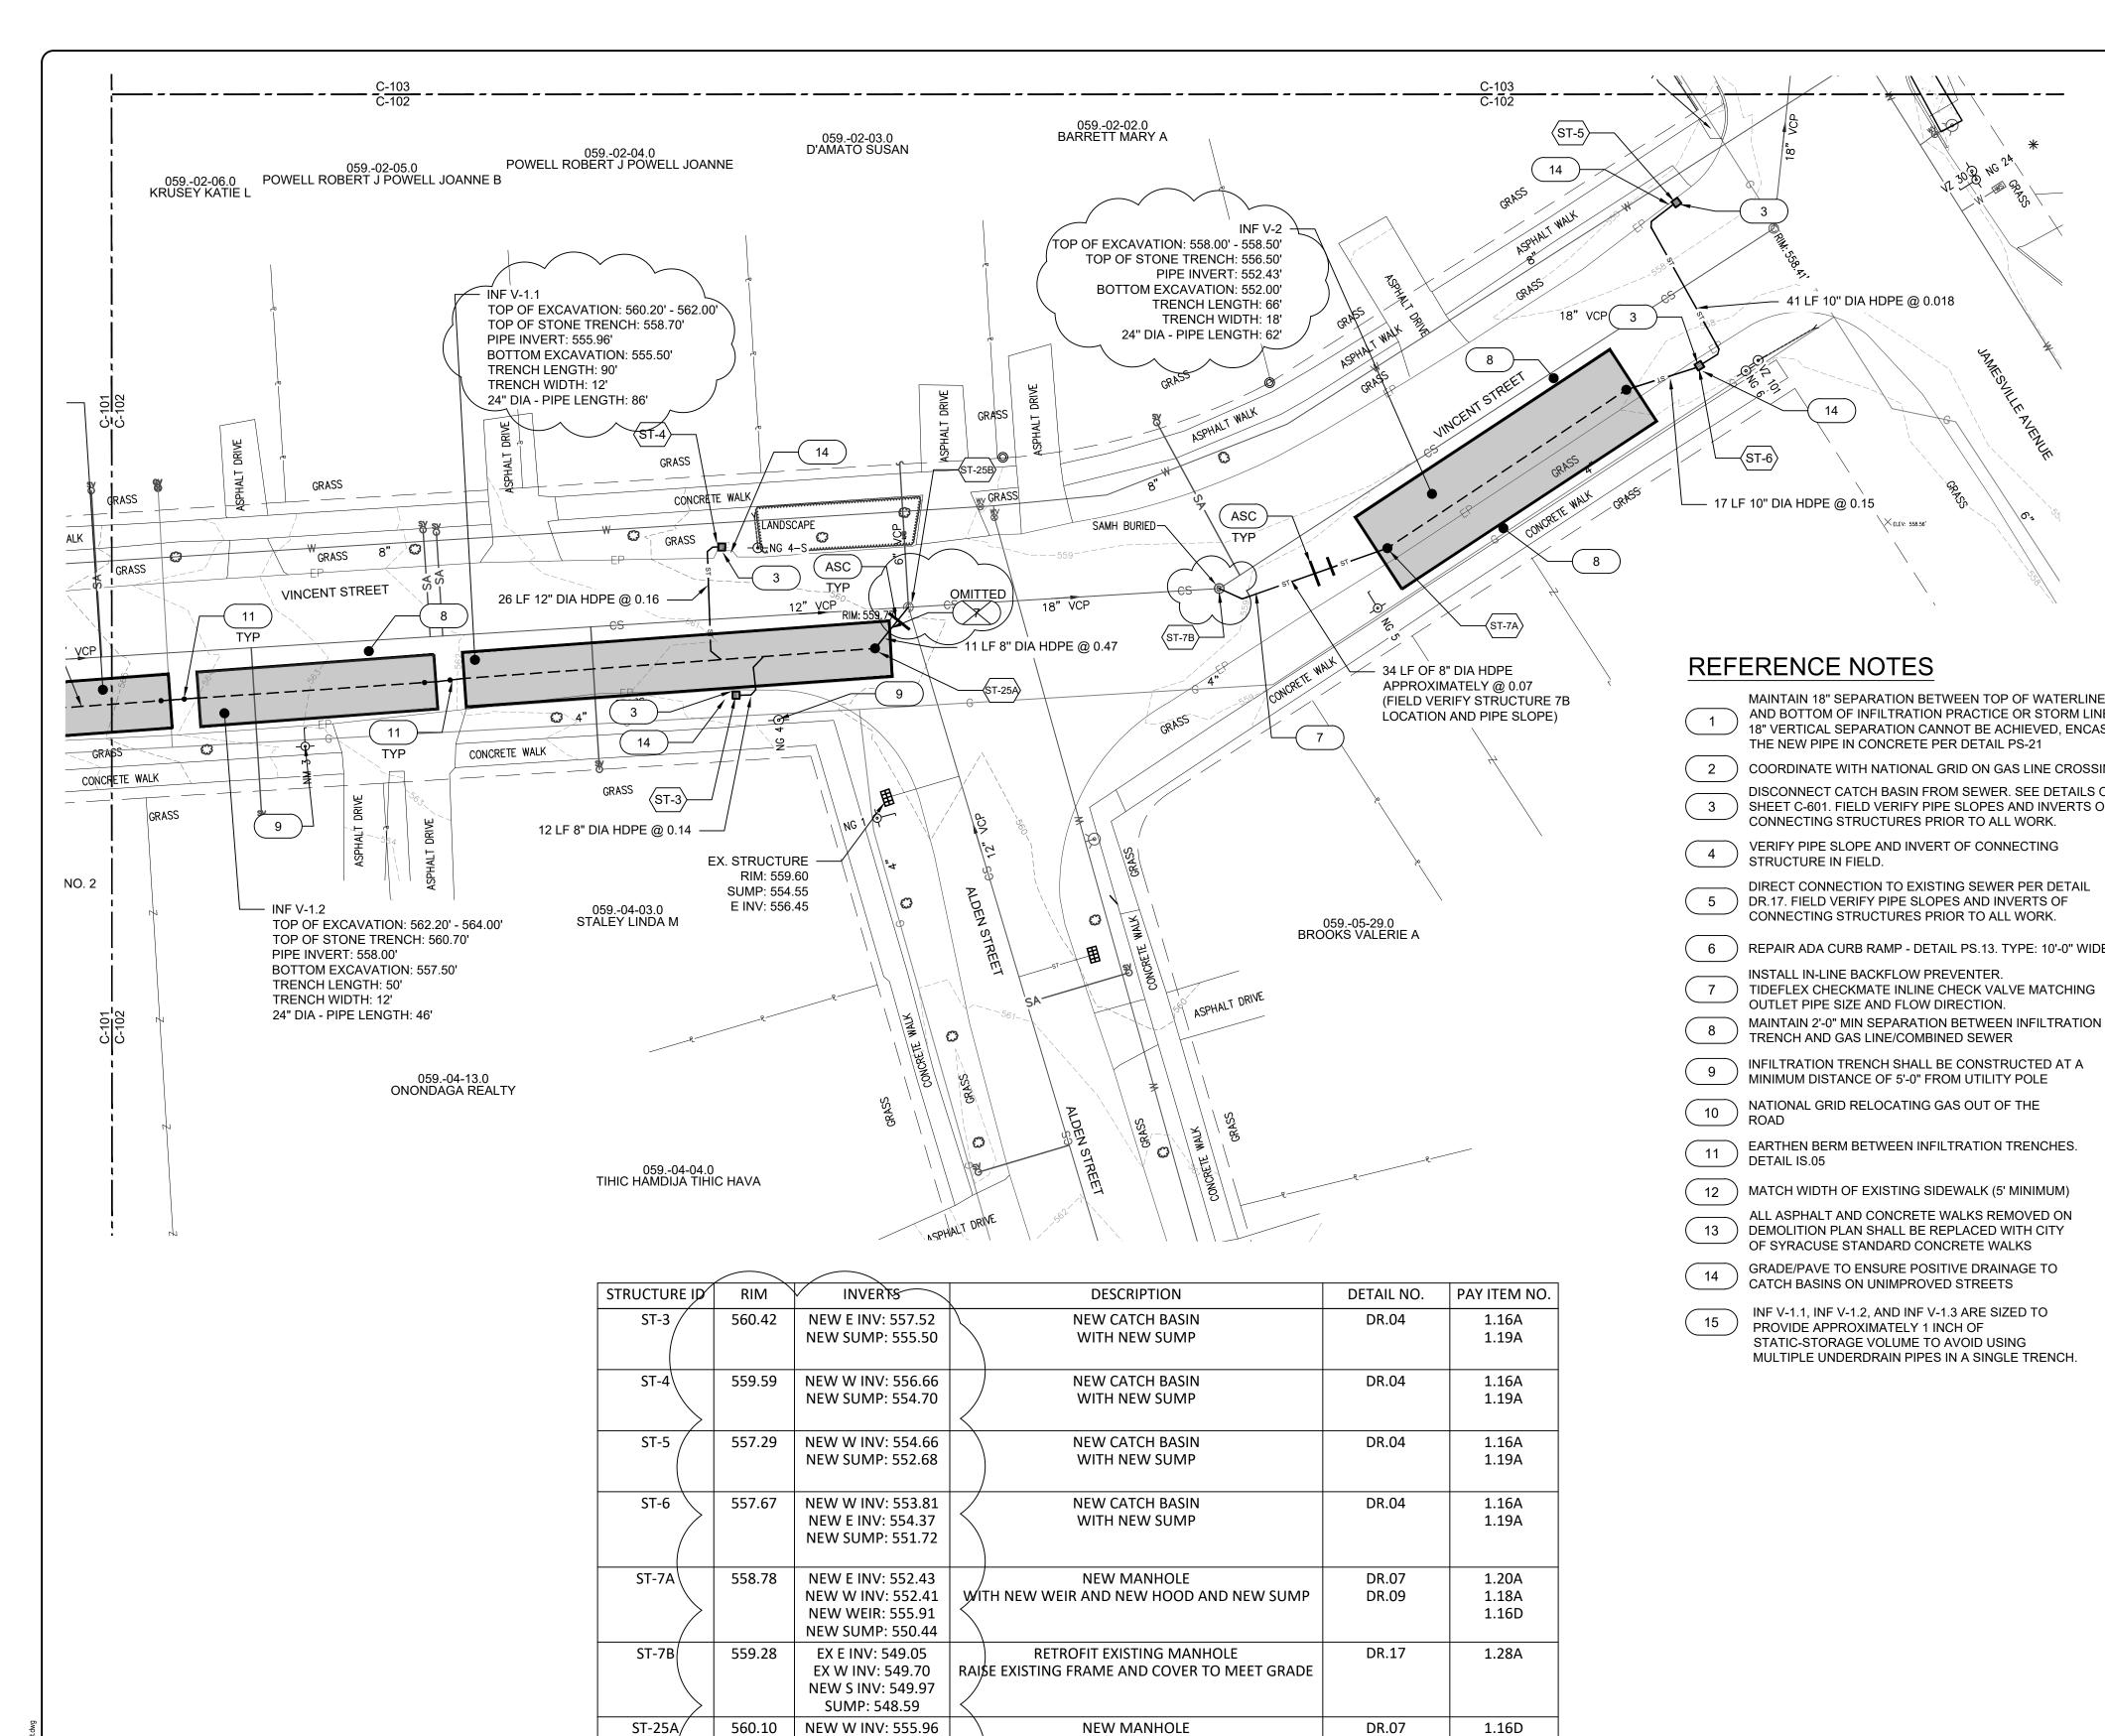
OUNTY SOW 119 GREEN STREET	rracuse, ny	NVIRONMENT PROTECTION	
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GA COUNTY WATER!

ONONDAGA

	•
\vdash	
	DATE: 5/14/2020
	SCALE: 1"=20'
	EDR Job#: 19008
	DRAWN BY: BL
	FILE NAME: VINCENT STREET

DRAWING NUMBER:



NEW NE INV: 555.91

NEW WEIR: 558.16

NEW SUMP: 553.97

EX N INV: 549.74

EX E INV: 548.83

EX S INV: 548.94

EX W INV: 549.12

NEW SW INV: 550.68

SUMP: 549.03

ALL WEIRS TO HAVE 1" ORIFICE AT THE SAME INVERT ELEVATION AS OUTLET PIPES TO THE COMBINED SEWER

ST-25B

559.77

WITH NEW WEIR AND NEW HOOD

AND NEW SUMP

RETROFIT EXISTING MANHOLE

FILTER INSERTS (PL1.19A) ARE REQUIRED ON ALL NEW AND EXISTING GRATED STRUCTURES TRIBUTARY TO THE INFILTRATION TRENCHES

DR.08

DR.09

DR.17

1.18A

1.20A

1.19A

1.28A

REFERENCE NOTES	SI	TE PLAN LEGEND		
MAINTAIN 18" SEPARATION BETWEEN TOP OF WATERLINE AND BOTTOM OF INFILTRATION PRACTICE OR STORM LINE. IF	ITEM	SYMBOL	PAY ITEM	DETAI
18" VERTICAL SEPARATION CANNOT BE ACHIEVED, ENCASE THE NEW PIPE IN CONCRETE PER DETAIL PS-21	INFILTRATION TRENCH			IS.01
2 COORDINATE WITH NATIONAL GRID ON GAS LINE CROSSINGS. DISCONNECT CATCH BASIN FROM SEWER. SEE DETAILS ON	CONCRETE SIDEWALK		1.40A	PS.11
3 SHEET C-601. FIELD VERIFY PIPE SLOPES AND INVERTS OF CONNECTING STRUCTURES PRIOR TO ALL WORK.	IMPERMEABLE LINER TRENCH SIDES ONLY	***************************************	1.33	
VERIFY PIPE SLOPE AND INVERT OF CONNECTING STRUCTURE IN FIELD.	STORM CATCH BASIN	III	1.16A	DR.04
DIRECT CONNECTION TO EXISTING SEWER PER DETAIL 5 DR.17. FIELD VERIFY PIPE SLOPES AND INVERTS OF	STORM MANHOLE	•	1.16D	DR.06
CONNECTING STRUCTURES PRIOR TO ALL WORK.	UNDERDRAIN		1.23B	
(6) REPAIR ADA CURB RAMP - DETAIL PS.13. TYPE: 10'-0" WIDE				

ANTI-SEEP COLLAR (ASC

STORM LINE

CLEANOUT

41 LF 10" DIA HDPE @ 0.018

CURB				1.35A & 1.35B	
STORM LINE PAY ITEI PIPE DIAMETER 8" 10" 12" 15" 18" 24" NOTES:	MS PAY ITEM 1.23B 1.23C 1.23D 1.23E 1.23F 1.23G	CAST IRON TRAP (DI PIPE DIAMETER 8" 10" 12" 15"	PAY ITE 1.20A 1.20B 1.20C 1.20D	_	
NOTES.					

- 1. GAS SERVICES SHALL BE WRAPPED PER DETAIL DR-23 2. ALL DISTURBED SIGNAGE SHALL BE RESET PER DETAIL TU.04
- 3. CONTRACTORS TO COORDINATE CONSTRUCTION WITH NATIONAL GRID

_____ ST _____ ST ____

SEE BELOW


1.27A


1.25

EXISITNG UTILITY		FEATURE:	MIN. OFFSET (FT):
TRENCH LENGTH		WATER LINE	5 HOR/1.5 VERT
THE NOTIFIE TO THE NAME OF THE		GAS LINE	2.0
CHART PIPE TENGTH	/	UG ELEC. LINE	3.0
SEE CHART SEE CHART SEE CHART	· ◆	STORM/SAN LIN	NE 2.0
		UTILITY STRUC	T. 3.0
G G G G G G G G G G G G G G G G G G G	G	UTILITY POLE	5.0
EXISITNG UTILITY		PROPERTY LIN	≣ 3.0
NOTE: MIN. OFFSETS MEASURED FROM OUTSIDE	OF PIPE OR	STRUCTURE	
SECTION VIEW	TRENCH DIME	ENSIONS	
FINISHED GRADE / TOP OF EXCAVATION			
TOP OF STONE TRENCH			N.
WQv ELEV: 1" STATIC / 10-YEAR 30 MIN WHICHEVER IS GREATER	- <u>i</u>		6" FREEBOARD
8" DIA. PERF HDPE UNDERDRAIN @ 0.00 —— OR AS SPECIFIED ON SITE PLAN			
TRENCH LINER AS CALLED OUT ON PLANS —	- ∦		
PIPE INVERT	iL \		
BOTTOM OF EXCAVATION	_		

AS BUILT DRAWING THESE DRAWINGS HAVE BEEN REVISED TO REFLECT MAJOR CHANGES, IF ANY, WHICH OCCURRED DURING CONSTRUCTION. REVISIONS ARE BASED UPON INFORMATION SUPPLIED BY CONTRACTOR. DATE: <u>2/19/2022</u> PER: <u>Michael E. Tamblin</u>


DRAWN BY: BL FII F NAMF: **VINCENT STREET** DRAWING NUMBER: GRAPHIC SCALE (IN FEET)

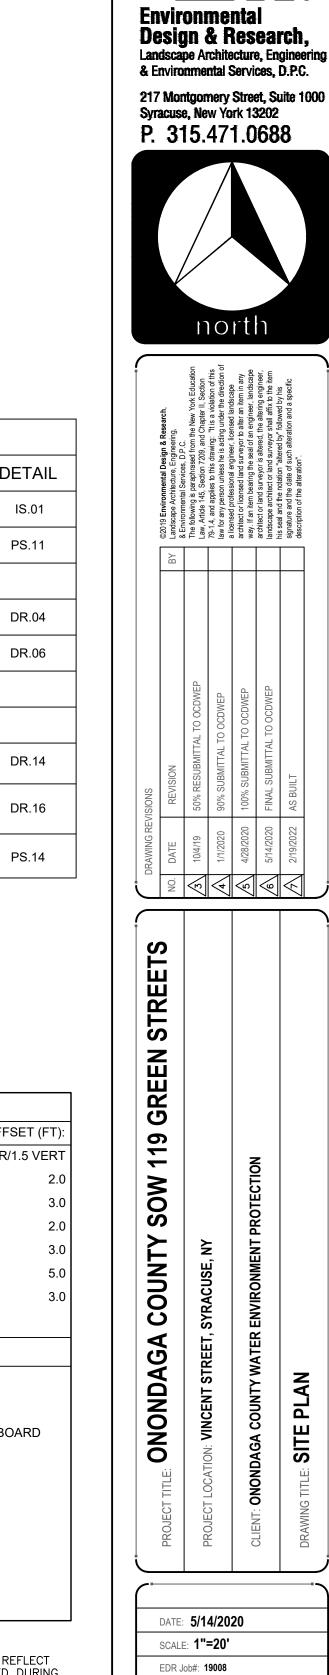

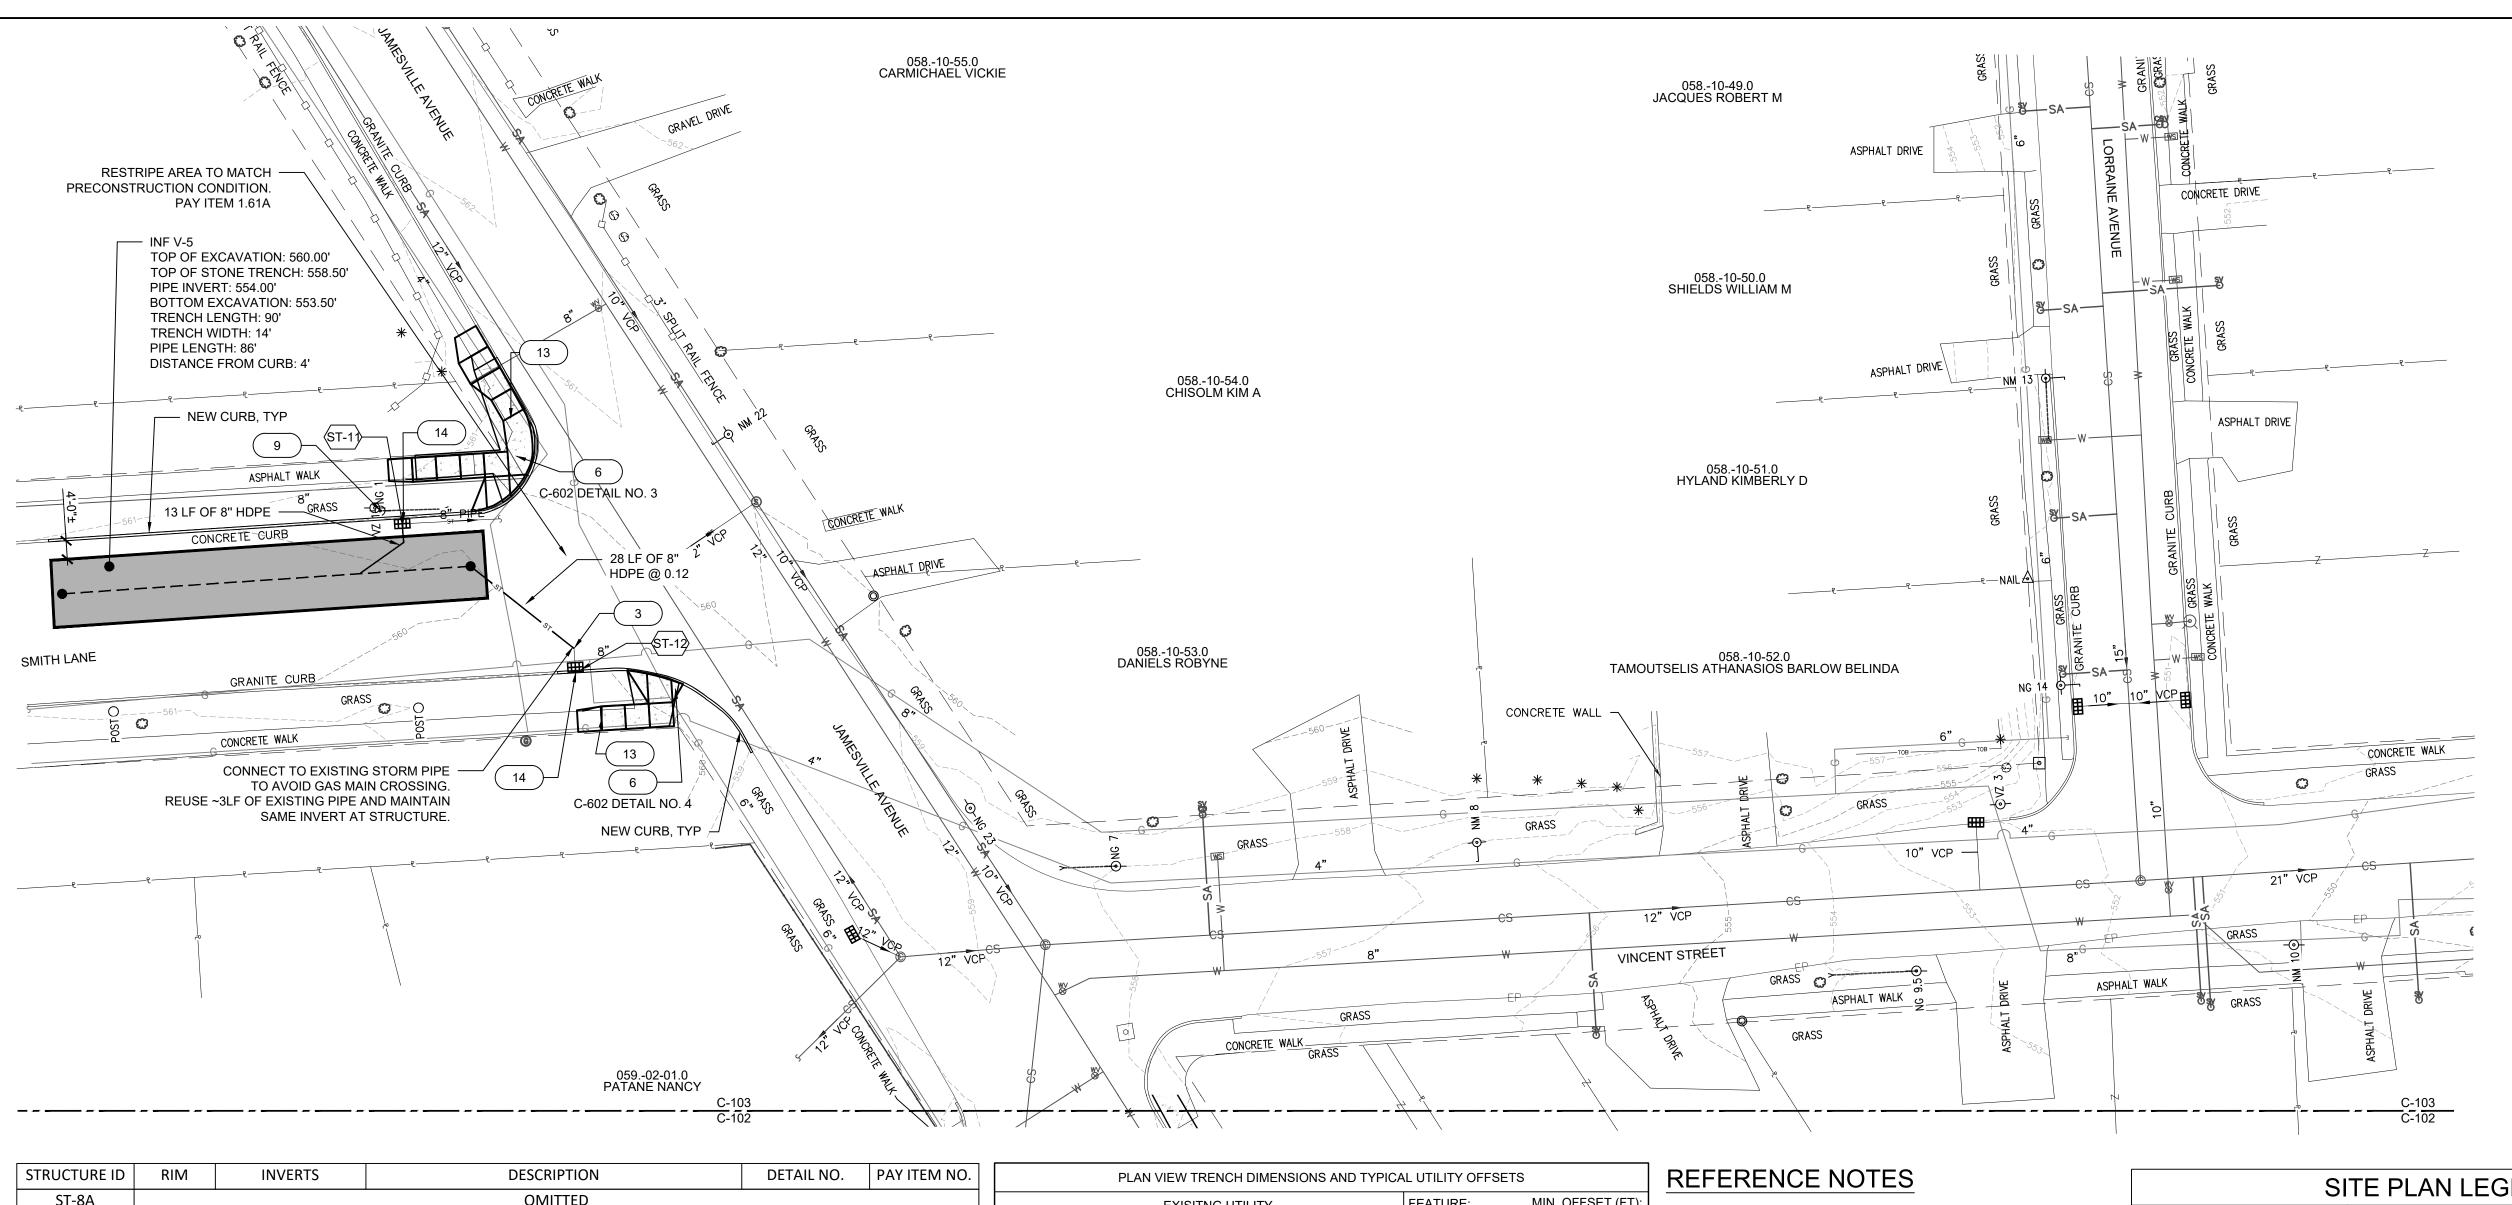

STRUCTURE ID	RIM	INVERTS		DESCRIPTION	DETAIL NO.	PAY ITEM NO.			
ST-8A		OMITTED							
ST-8B		OMITTED							
ST-9A				OMITTED					
ST-9B				OMITTED					
ST-10			$\overline{}$	OMITTED					
ST-11	559.72	EX E INV: 556.01 NEW S INV: 556.75 NEW WEIR: 558.49 EX SUMP: 554.29		RETROFIT EXISTING CATCH BASIN WITH NEW WEIR REATTACH HOOD	DR.17	1.28A 1.19A			
ST-12	559.45	EX N INV: 557.11 NEW N INV: 555.76 EX SUMP: 553.57		RETROFIT EXISTING CATCH BASIN	DR.17 DR.09	1.28A 1.18A 1.19A			
ST-13		\wedge		OMITTED	•				
ST-14A				OMITTED					
ST-14B	OMITTED								
ST-15		OMITTED							
ST-15B				OMITTED					

FILTER INSERTS (PI 1.19A) ARE REQUIRED ON ALL NEW AND EXISTING GRATED STRUCTURES TRIBUTARY TO THE INFILTRATION TRENCHES ALL WEIRS TO HAVE 1" ORIFICE AT THE SAME INVERT ELEVATION AS OUTLET PIPES TO THE COMBINED SEWER

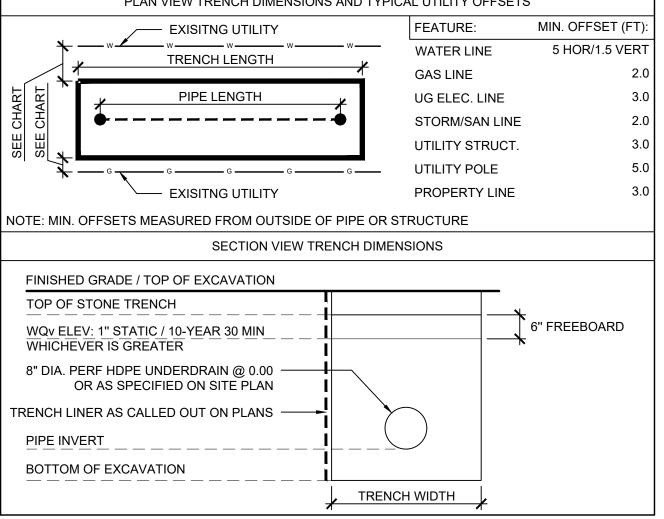

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AND BOTTOM OF INFILTRATION PRACTICE OR STORM LINE. IF
18" VERTICAL SEPARATION CANNOT BE ACHIEVED, ENCASE

2 COORDINATE WITH NATIONAL GRID ON GAS LINE CROSSINGS.
DISCONNECT CATCH BASIN FROM SEWER. SEE DETAILS ON SHEET C-601. FIELD VERIFY PIPE SLOPES AND INVERTS OF CONNECTING STRUCTURES PRIOR TO ALL WORK.

THE NEW PIPE IN CONCRETE PER DETAIL PS-21

VERIFY PIPE SLOPE AND INVERT OF CONNECTING STRUCTURE IN FIELD.

DIRECT CONNECTION TO EXISTING SEWER PER DETAIL DR.17. FIELD VERIFY PIPE SLOPES AND INVERTS OF CONNECTING STRUCTURES PRIOR TO ALL WORK.

6 REPAIR ADA CURB RAMP - DETAIL PS.13. TYPE: 10'-0" WIDE

INSTALL IN-LINE BACKFLOW PREVENTER.
TIDEFLEX CHECKMATE INLINE CHECK VALVE MATCHING OUTLET PIPE SIZE AND FLOW DIRECTION.

MAINTAIN 2'-0" MIN SEPARATION BETWEEN INFILTRATION TRENCH AND GAS LINE/COMBINED SEWER

9 INFILTRATION TRENCH SHALL BE CONSTRUCTED AT A MINIMUM DISTANCE OF 5'-0" FROM UTILITY POLE

NATIONAL GRID RELOCATING GAS OUT OF THE

ROAD

EARTHEN BERM BETWEEN INFILTRATION TRENCHES.
DETAIL IS.05

12 MATCH WIDTH OF EXISTING SIDEWALK (5' MINIMUM)

ALL ASPHALT AND CONCRETE WALKS REMOVED ON DEMOLITION PLAN SHALL BE REPLACED WITH CITY OF SYRACUSE STANDARD CONCRETE WALKS

GRADE/PAVE TO ENSURE POSITIVE DRAINAGE TO CATCH BASINS ON UNIMPROVED STREETS

	SI	TE PLAN LEGEND		
= I	TEM	SYMBOL	PAY ITEM	DETAIL
INFILTRATION	TRENCH			IS.01
CONCRETE SI	DEWALK		1.40A	PS.11
IMPERMEABLE TRENCH SIDE			1.33	
STORM CATCH	H BASIN		1.16A	DR.04
STORM MANH	OLE	•	1.16D	DR.06
UNDERDRAIN			1.23B	
STORM LINE		ST ST	SEE BELOW	
CLEANOUT		•	1.27A	DR.14
ANTI-SEEP CO	OLLAR (ASC)	ST ST	1.25	DR.16
CURB			1.35A & 1.35B	PS.14

STORM LINE PAY ITE	MC	CAST IRON TRAP (D	ETAIL DROS
PIPE DIAMETER	PAY ITEM	PIPE DIAMETER	PAY ITEM
8"	1.23B	8"	1.20A
10"	1.23C	10"	1.20B
12"	1.23D	12"	1.20C
15"	1.23E	15"	1.20D
18"	1.23F		
24"	1.23G		
NOTES:			

NOTES:

1. GAS SERVICES SHALL BE WRAPPED PER DETAIL DR-23

2. ALL DISTURBED SIGNAGE SHALL BE RESET PER DETAIL TU.04

3. CONTRACTORS TO COORDINATE CONSTRUCTION WITH NATIONAL GRID

AS BUILT DRAWING
THESE DRAWINGS HAVE BEEN REVISED TO

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DATE: <u>2/19/2022</u> PER: <u>Michael E. Tamblin</u>


20 10 0 10 20 40

GRAPHIC SCALE (IN FEET)



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Syracuse, New York 13202

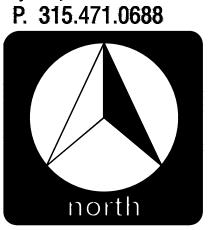

NG RE\	DRAWING REVISIONS	
DATE	REVISION	ВУ
10/4/19	50% RESUBMITTAL TO OCDWEP	
1/1/2020	90% SUBMITTAL TO OCDWEP	
/2020	4/28/2020 100% SUBMITTAL TO OCDWEP	
5/14/2020	FINAL SUBMITTAL TO OCDWEP	
2/19/2022	AS BUILT	


ONONDAGA COUNTY SOW 119 GREEN STREETS

ON: VINCENT STREET, SYRACUSE, NY


AGA COUNTY WATED ENVIRONMENT BROTECTION

DAT	E: 5/14/20	20	
904	LE: 1"=20'		
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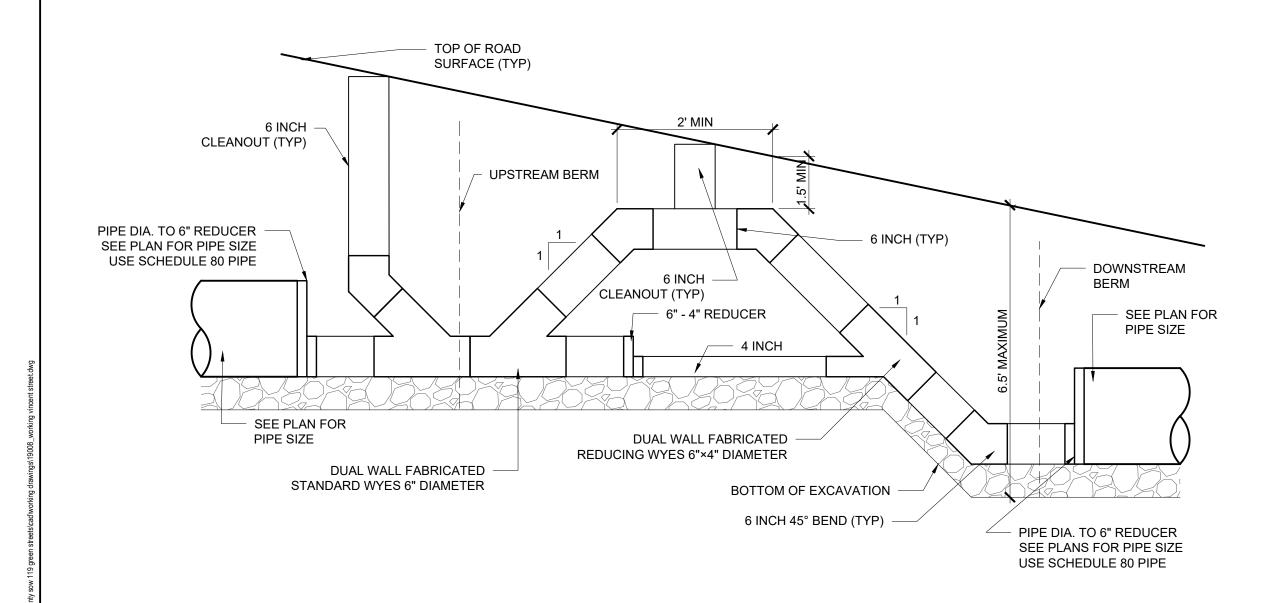
STORM PIPE ABANDONMENT Scale: NTS

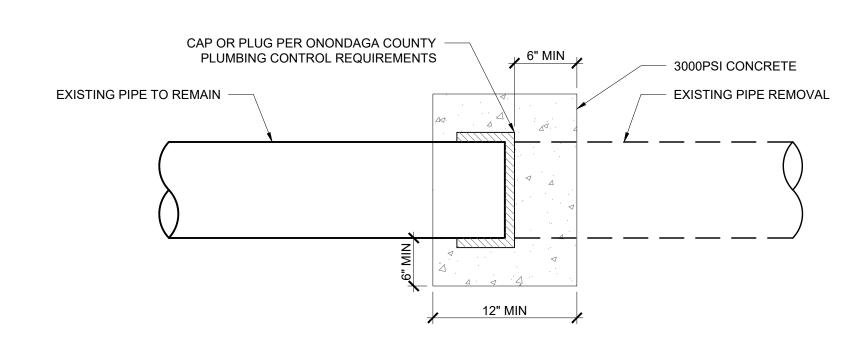


WATER SERVICE THROUGH GREEN INFRASTRUCTURE PROTECTION

Scale: NTS

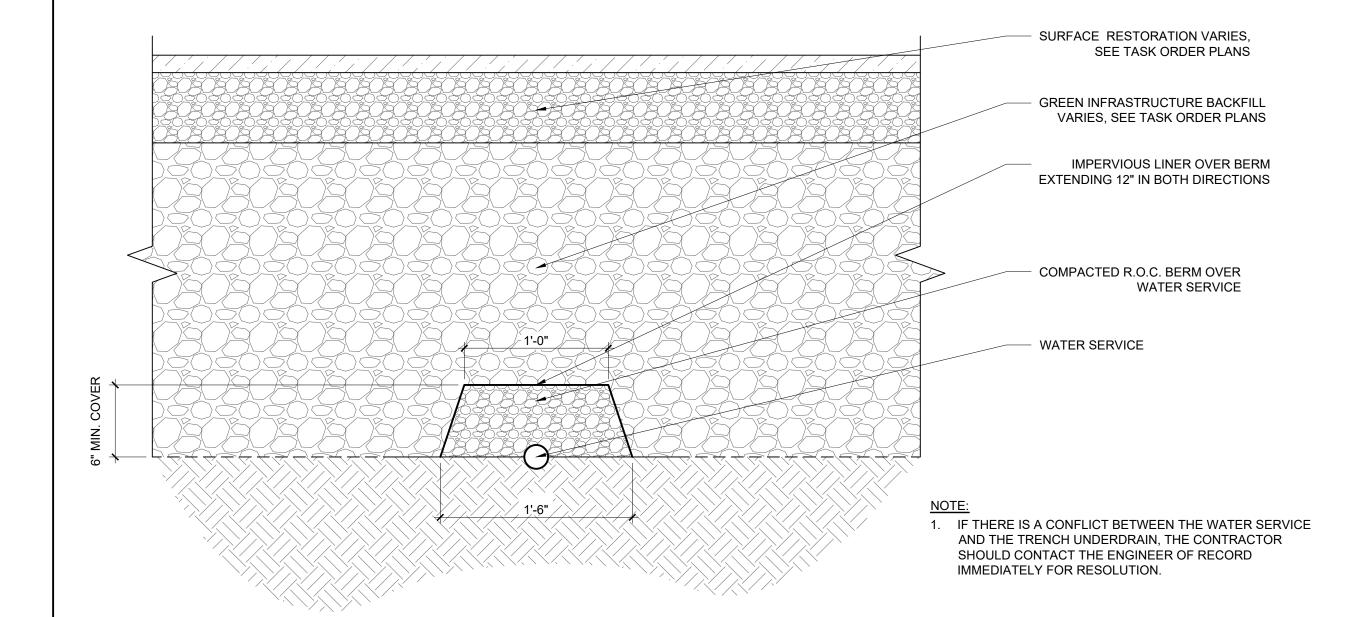TU.01A



BERM CROSS SECTION (TYP)

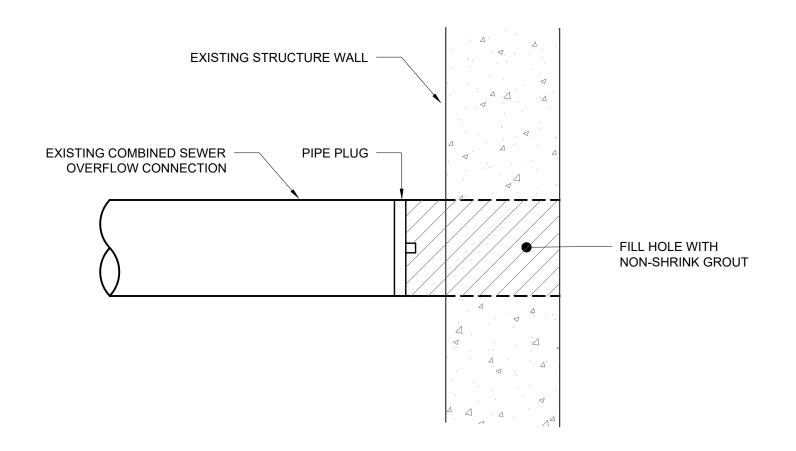

2) ALTERNATIVE STORM PIPE ABANDONMENT
Scale: NTS



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SIONS REVISION 50% RESUBMITTAL TO OCDWEP 90% SUBMITTAL TO OCDWEP 100% SUBMITTAL TO OCDWEP FINAL SUBMITTAL TO OCDWEP AS BUILT	DRAWING REVISIONS DATE REVISION 10/4/19 50% RESUBMITTAL TO OCDWEP 1/1/2020 90% SUBMITTAL TO OCDWEP 4/28/2020 100% SUBMITTAL TO OCDWEP 5/14/2020 FINAL SUBMITTAL TO OCDWEP 2/19/2022 AS BUILT		C2019 Environmental Design & Research, Landscape Architecture, Engineering, R. Furincomental Services D.P.C.	The following is paraphrased from the New York Education Law, Article 145, Section 7209, and Chapter II, Section	79-1.4, and applies to this drawing: "It is a violation of this thing who ran y person unless it is adring under the direction of law or any person unless it is adring under the direction of law or any person unless it is adring under the direction of law or any or an	architect or licensed land surveyor to alter an item in any way. If an item bearing the seal of an engineer, landscape	architect or land surveyor is altered, the altering engineer, landscape authlietor or land surveyor shall affix to the Item his road and the network program "shared by "fallound by big	signature and the date of such alteration and a specific description of the alteration".	
	DATE 10/4/19 1/1/2020 4/28/2020 5/14/2020	SIONS	REVISION	50% RESUBMITTAL TO OCDWEP	90% SUBMITTAL TO OCDWEP	100% SUBMITTAL TO OCDWEP	FINAL SUBMITTAL TO OCDWEP	AS BUILT	

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OCATION: VINCENT STDEET SYDACIISE NY	∞	3 10/4/19	4,
		1/1/2020	- 0,
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NONDAGA COOM I WALEN ENVINONMEN TROLECTON		5/14/2020	
	<u> </u>	A 2/19/2022	

AS BUILT DRAWING

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DATE: <u>2/19/2022</u> PER: <u>Michael E. Tamblin</u>

VINCENT STREET


DRAWING NUMBER:

C-601

DATE: **5/14/2020**SCALE: **NTS**

EDR Job#: 19008


DRAWN BY: BL

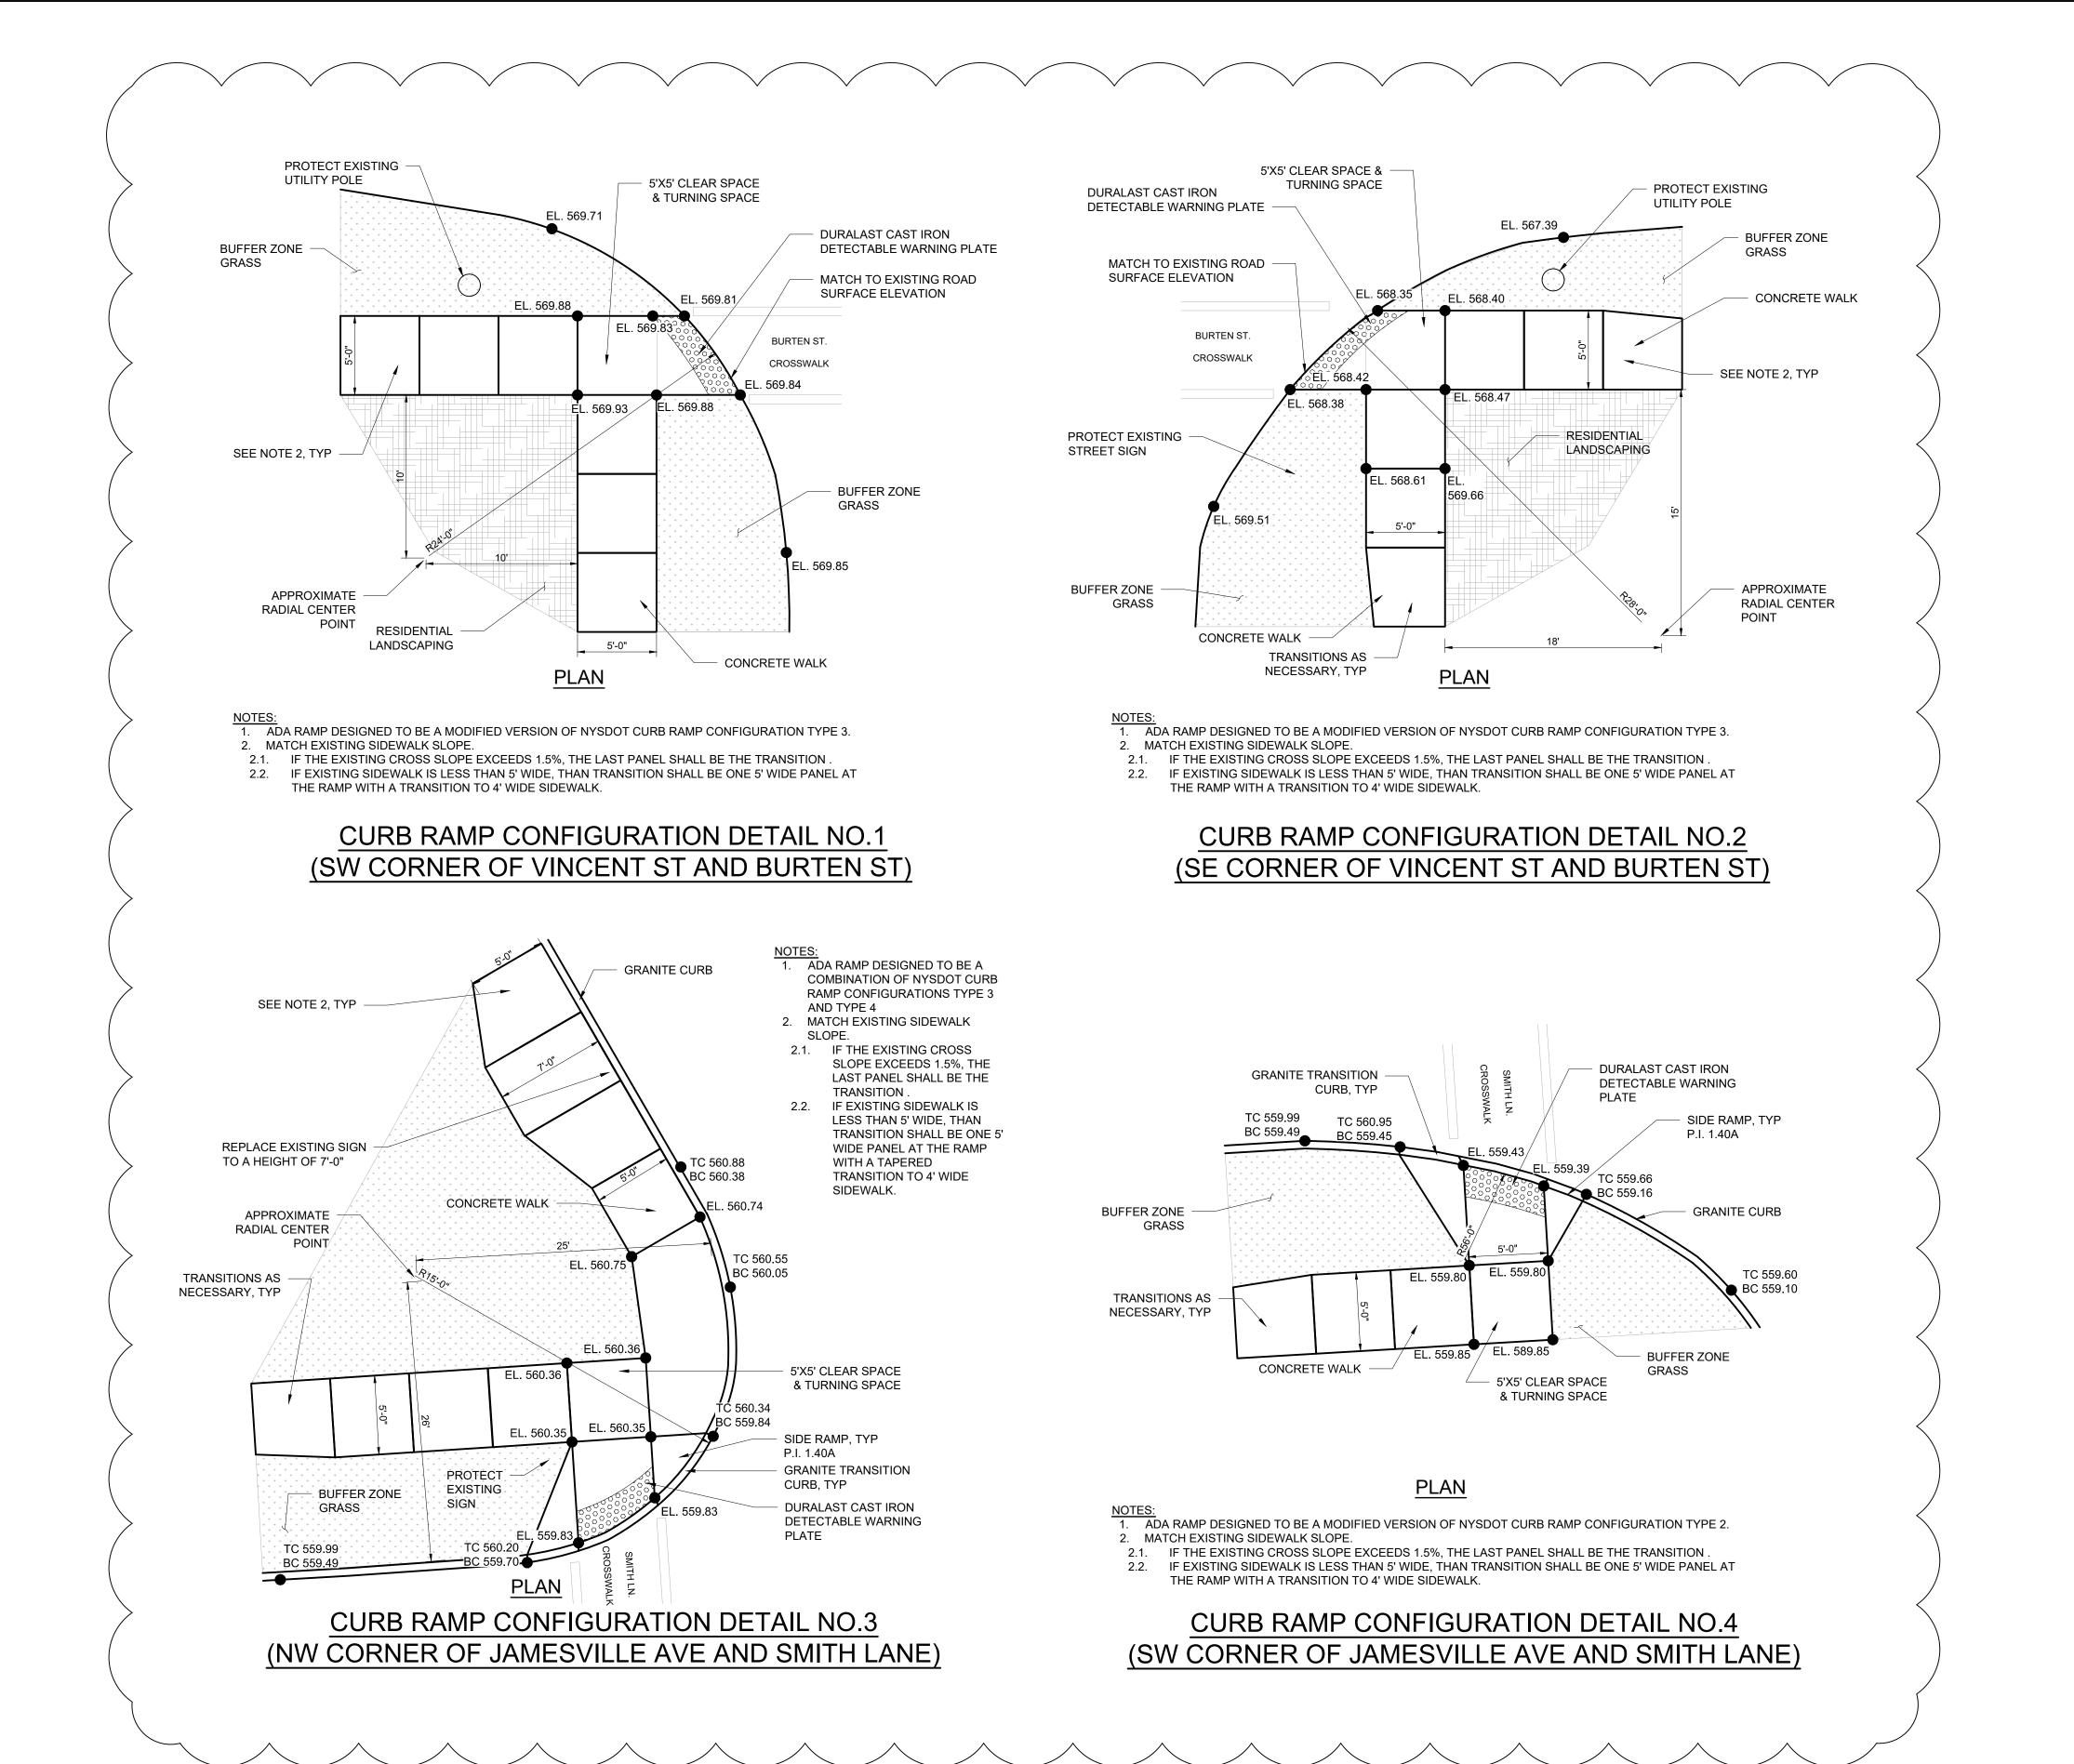

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			1/1/2020 90	4/28/2020 10	5/14/2020 FI	2/19/2022 AS BUILT

TY SOW 119 GREEN STREETS, NY
ENT PROTECTION

CT LITLE: ONONDAGA COUNTY SOW CT LOCATION: VINCENT STREET, SYRACUSE, NY

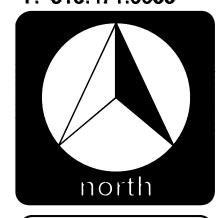PROJECT LOCATION: VINCENT STREET, S'
CLIENT: ONONDAGA COUNTY WATER E

DATE: 5/14/2020 SCALE: NTS EDR Job#: 19008

EDR Job#: 19008 DRAWN BY: BL

FILE NAME:
VINCENT STREET

C-602

AS BUILT DRAWING

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